



1202-A Pollock Street
New Bern, NC 28560
252-633-0322
www.goarchdesign.com

DOPING REPORTED OF THE ARCHITECT.

SE PLANS ARE THE PROPERTY OF THE ARCHITECT.

SE PLANS CONTAIN PROPRIETARY INFORMATION OF ARCHITECTURAL DESIGN, PLLC. THEY ARE SUBJECT SEDERAL COPYRIGHT AND OTHER APPLICABLE STALL AND STATE PROPERTY, TRADE AND RELATED S. THESE PLANS, INCLUDING THE INFORMATION ITAINED WITHIN, SHALL NOT BE SHARED, RODUCED, DISTRIBUITED OR USED IN ANY WAY HOUT WRITTEN CONSENT FROM THE ARCHITECT. FAILURE TO OBTAIN SUCH CONSENT IS A VIOLATION AW, AND MAY BE SUBJECT TO CIVIL AND CRIMINAL OSECUTION AND RESURE STATES.

Revisions:


## CUSTOM HOME

NEW BERN, NC 28560

A-501
EXTERIOR RENDERINGS

INLVV DLIXIN, INC 2

# CUSTOM HOME

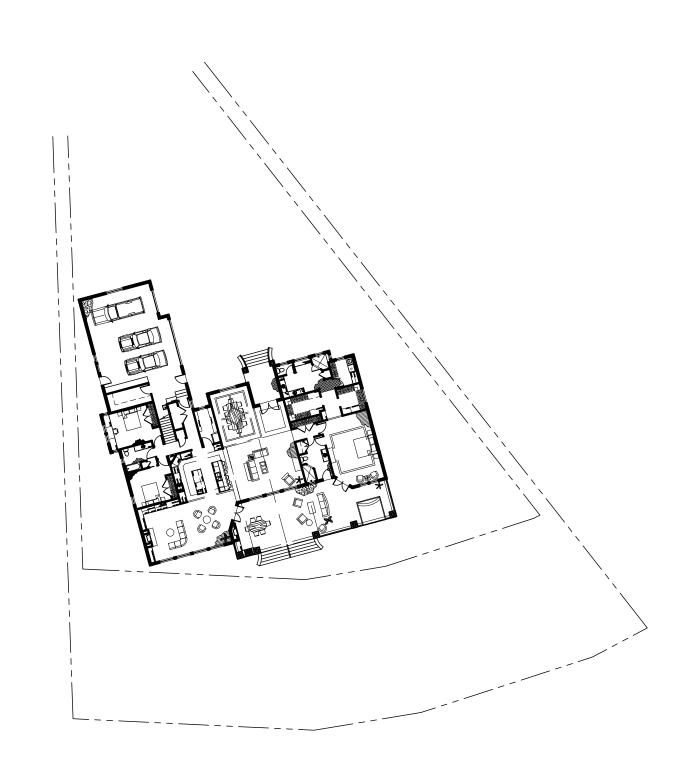





Revisions:

## **KEYS & SYMBOLS** DOOR & WINDOW SIZE KEY = 2'-6" WIDE (ASSUME STANDARD DOOR HEIGHT OF 6'-8" UNLESS NOTED) 2060 = 2'-0" WIDE X 6'-0" HIGH DRAWING NUMBER— CEILING HEIGHT AND — SQUARE FOOTAGE - Drawing Number FIRST FLOOR PLAN

#### SHEET SCHEDULE

G-101 TITLE SHEET

A-101 FIRST FLOOR PLAN

A-102 FIRST FLOOR PLAN CONT.

A-103 SECOND FLOOR PLAN

A-104 REFLECTED CEILING PLAN

A-105 ROOF PLAN

A-106 FOUNDATION PLAN

A-201 ELEVATIONS

A-202 ELEVATIONS CONT.

A-203 ENLARGED PLANS & INT ELEVATIONS

A-204 INTERIOR ELEVATIONS

A-301 BUILDING SECTIONS

A-401 WALL DETAILS

#### NET SQUARE FOOTAGE

NON HEATED

GARAGE 922 SF STORAGE 87 SF 119 SF COVERED PORCH COVERED LANAI 885 SF

HEATED / COOLED

FIRST FLOOR PLAN 3,317 SF SECOND FLOOR PLAN 650 SF 3,967 SF **TOTAL** 

IT IS THE SOLE RESPONSIBILITY OF THE CONTRACTOR AND/OR BUILDER TO CONFIRM TO ALL STANDARDS, PROVISIONS, REQUIREMENTS, METHODS OF CONSTRUCTION AND USES OF MATERIALS PROVIDED IN BUILDINGS AND/OR STRUCTURES AS REQUIRED BY N.C. UNIFORM BUILDING CODE, LOCAL AGENCIES AND IN ACCORDANCE WITH GOOD CONSTRUCTION. VERIFY ALL COLOR AND MATERIAL CHOICES WITH OWNER PRIOR TO ORDERING OR INSTALLING.



1202-A Pollock Street New Bern, NC 28560 2 5 2 - 6 3 3 - 0 3 2 2 www.goarchdesign.com


THESE PLANS ARE THE PROPERTY OF THE ARCHITECT. THESE PLANS CONTAIN PROPRIETARY INFORMATION OF GO ARCHITECTURAL DESIGN, PLLC. THEY ARE SUBJECT TO FEDERAL COPYRIGHT AND OTHER APPLICABLE FEDERAL AND STATE PROPERTY, TRADE AND RELATED LAWS. THESE PLANS, INCLUDING THE INFORMATION CONTAINED WITHIN, SHALL NOT BE SHARED, REPRODUCED, DISTRIBUITED OR USED IN ANY WAY WITHOUT WRITTEN CONSENT FROM THE ARCHITECT. ANY FAILURE TO OBTAIN SUCH CONSENT IS A VIOLATION OF LAW, AND MAY BE SUBJECT TO CIVIL AND CRIMINAL PROSECUTION AND PENALTIES.


CUSTOM HOME

NEW BERN, NC 28560

G-101

TITLE SHEET

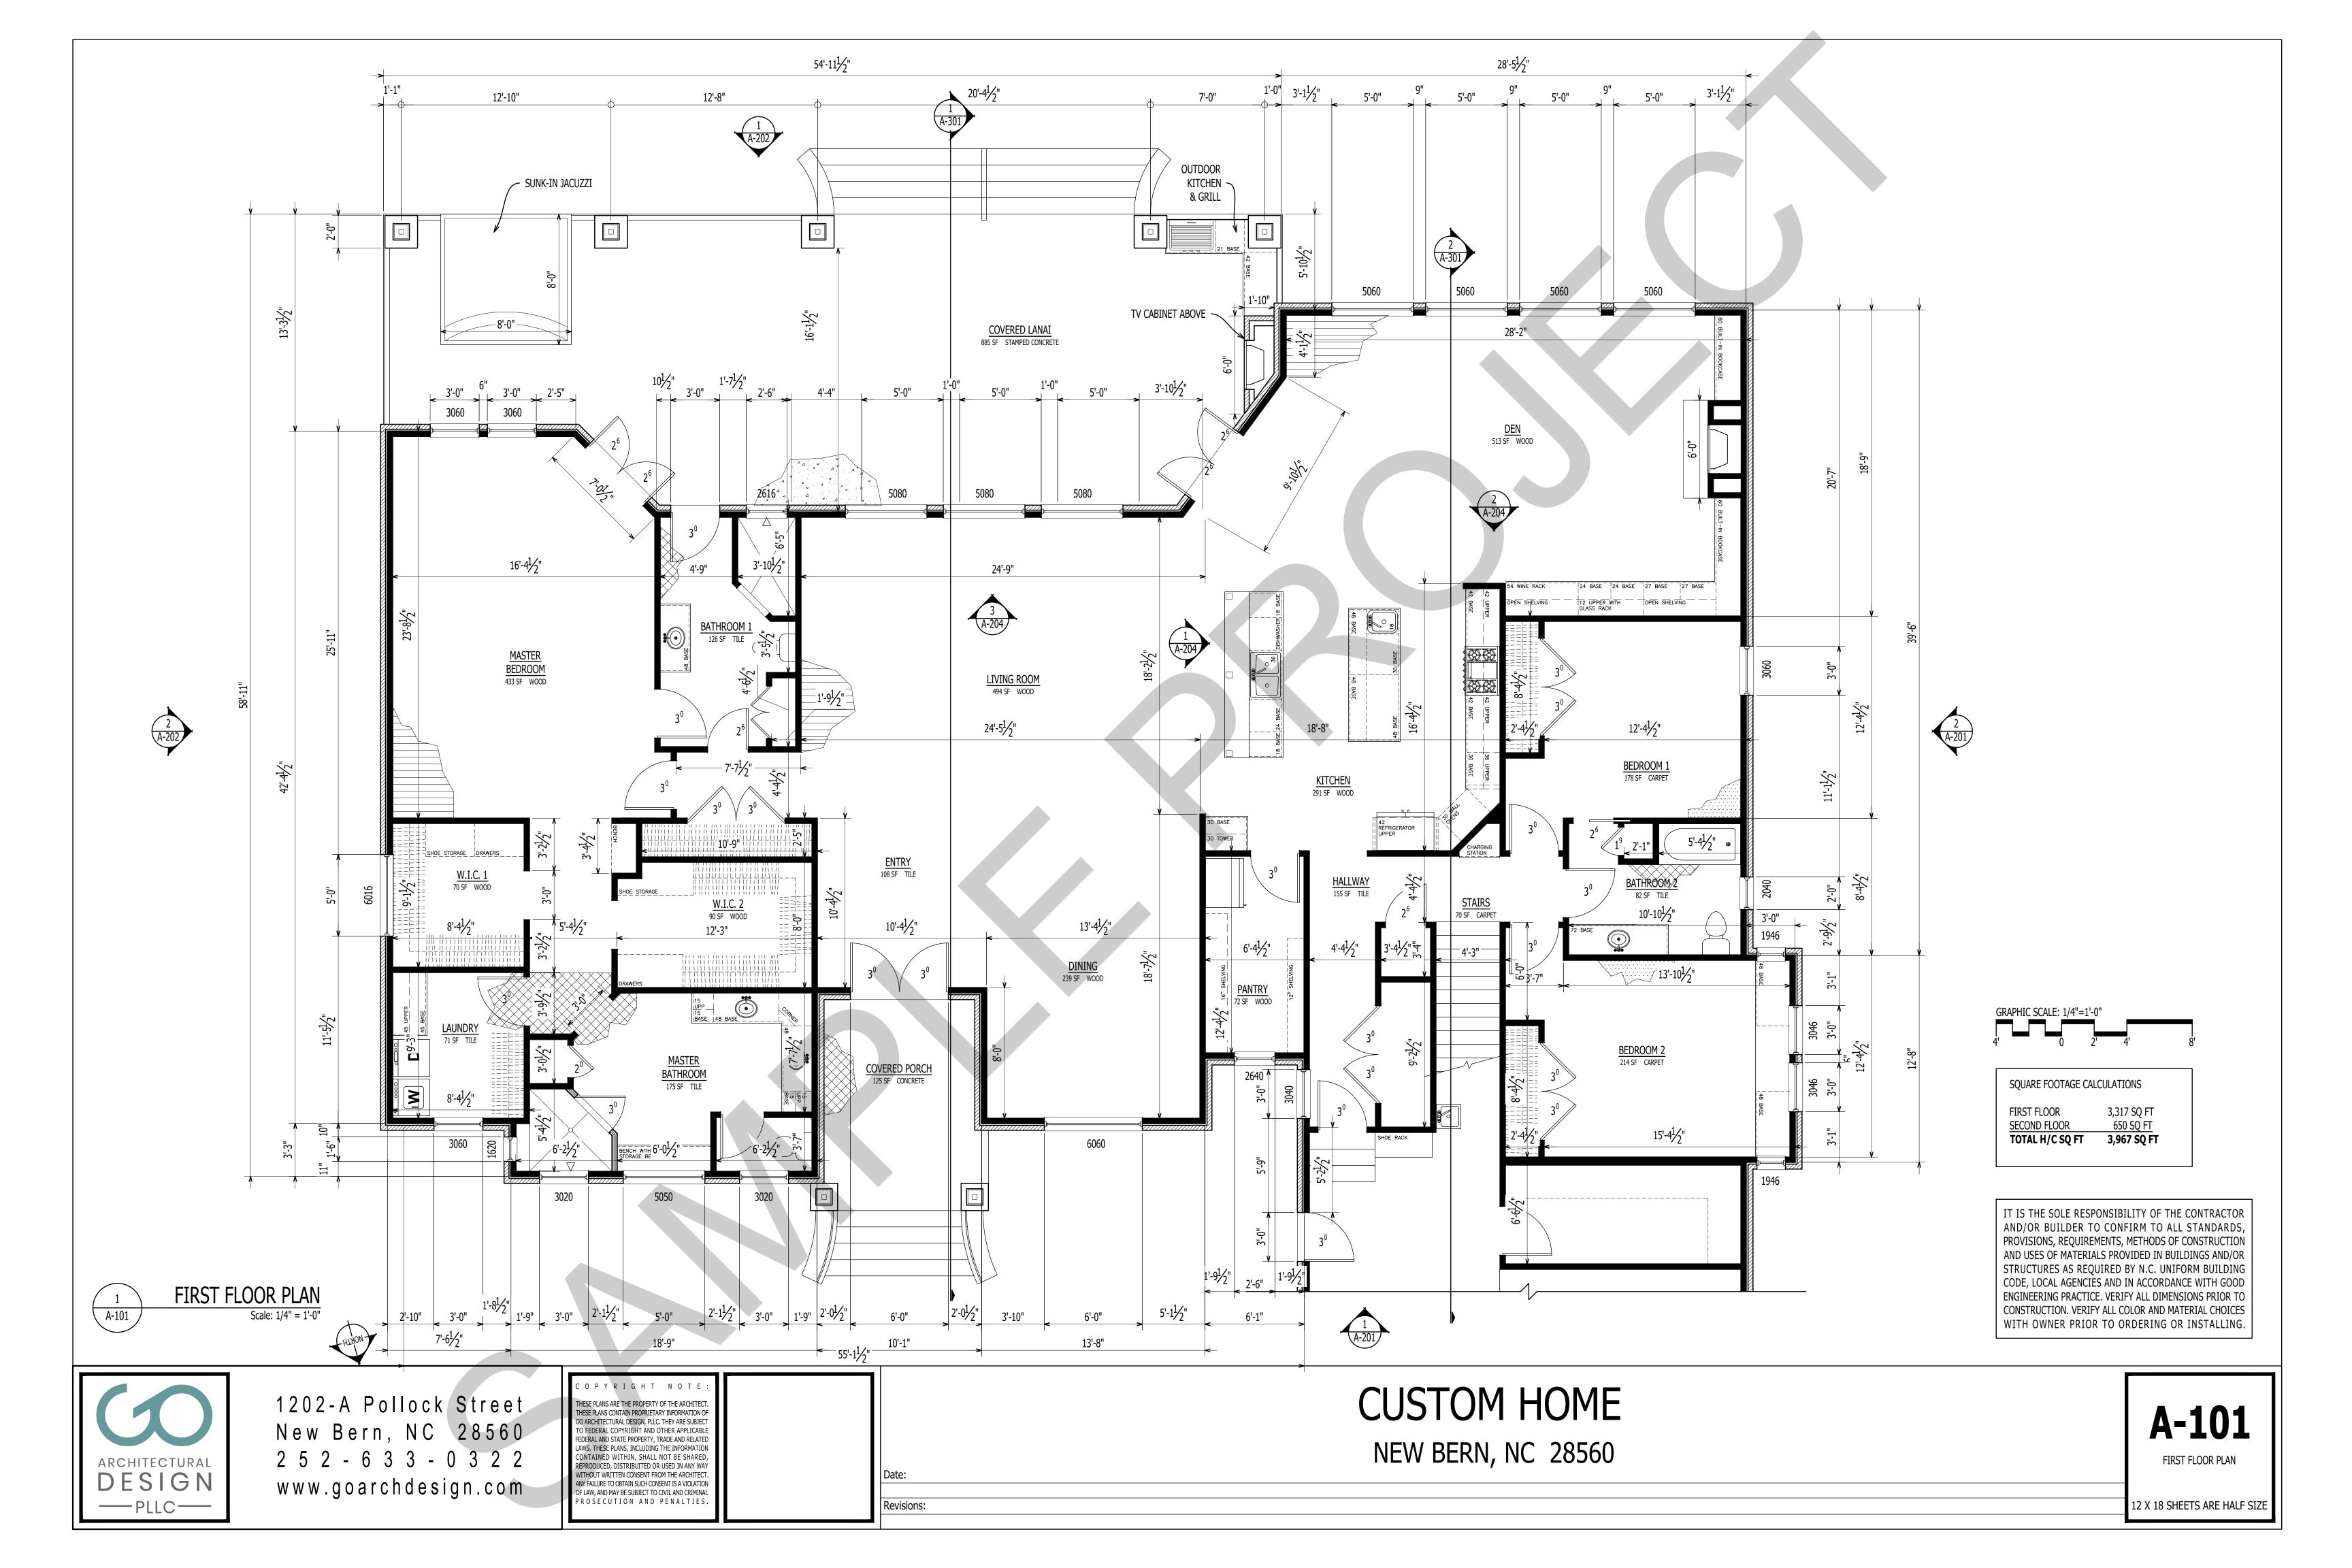

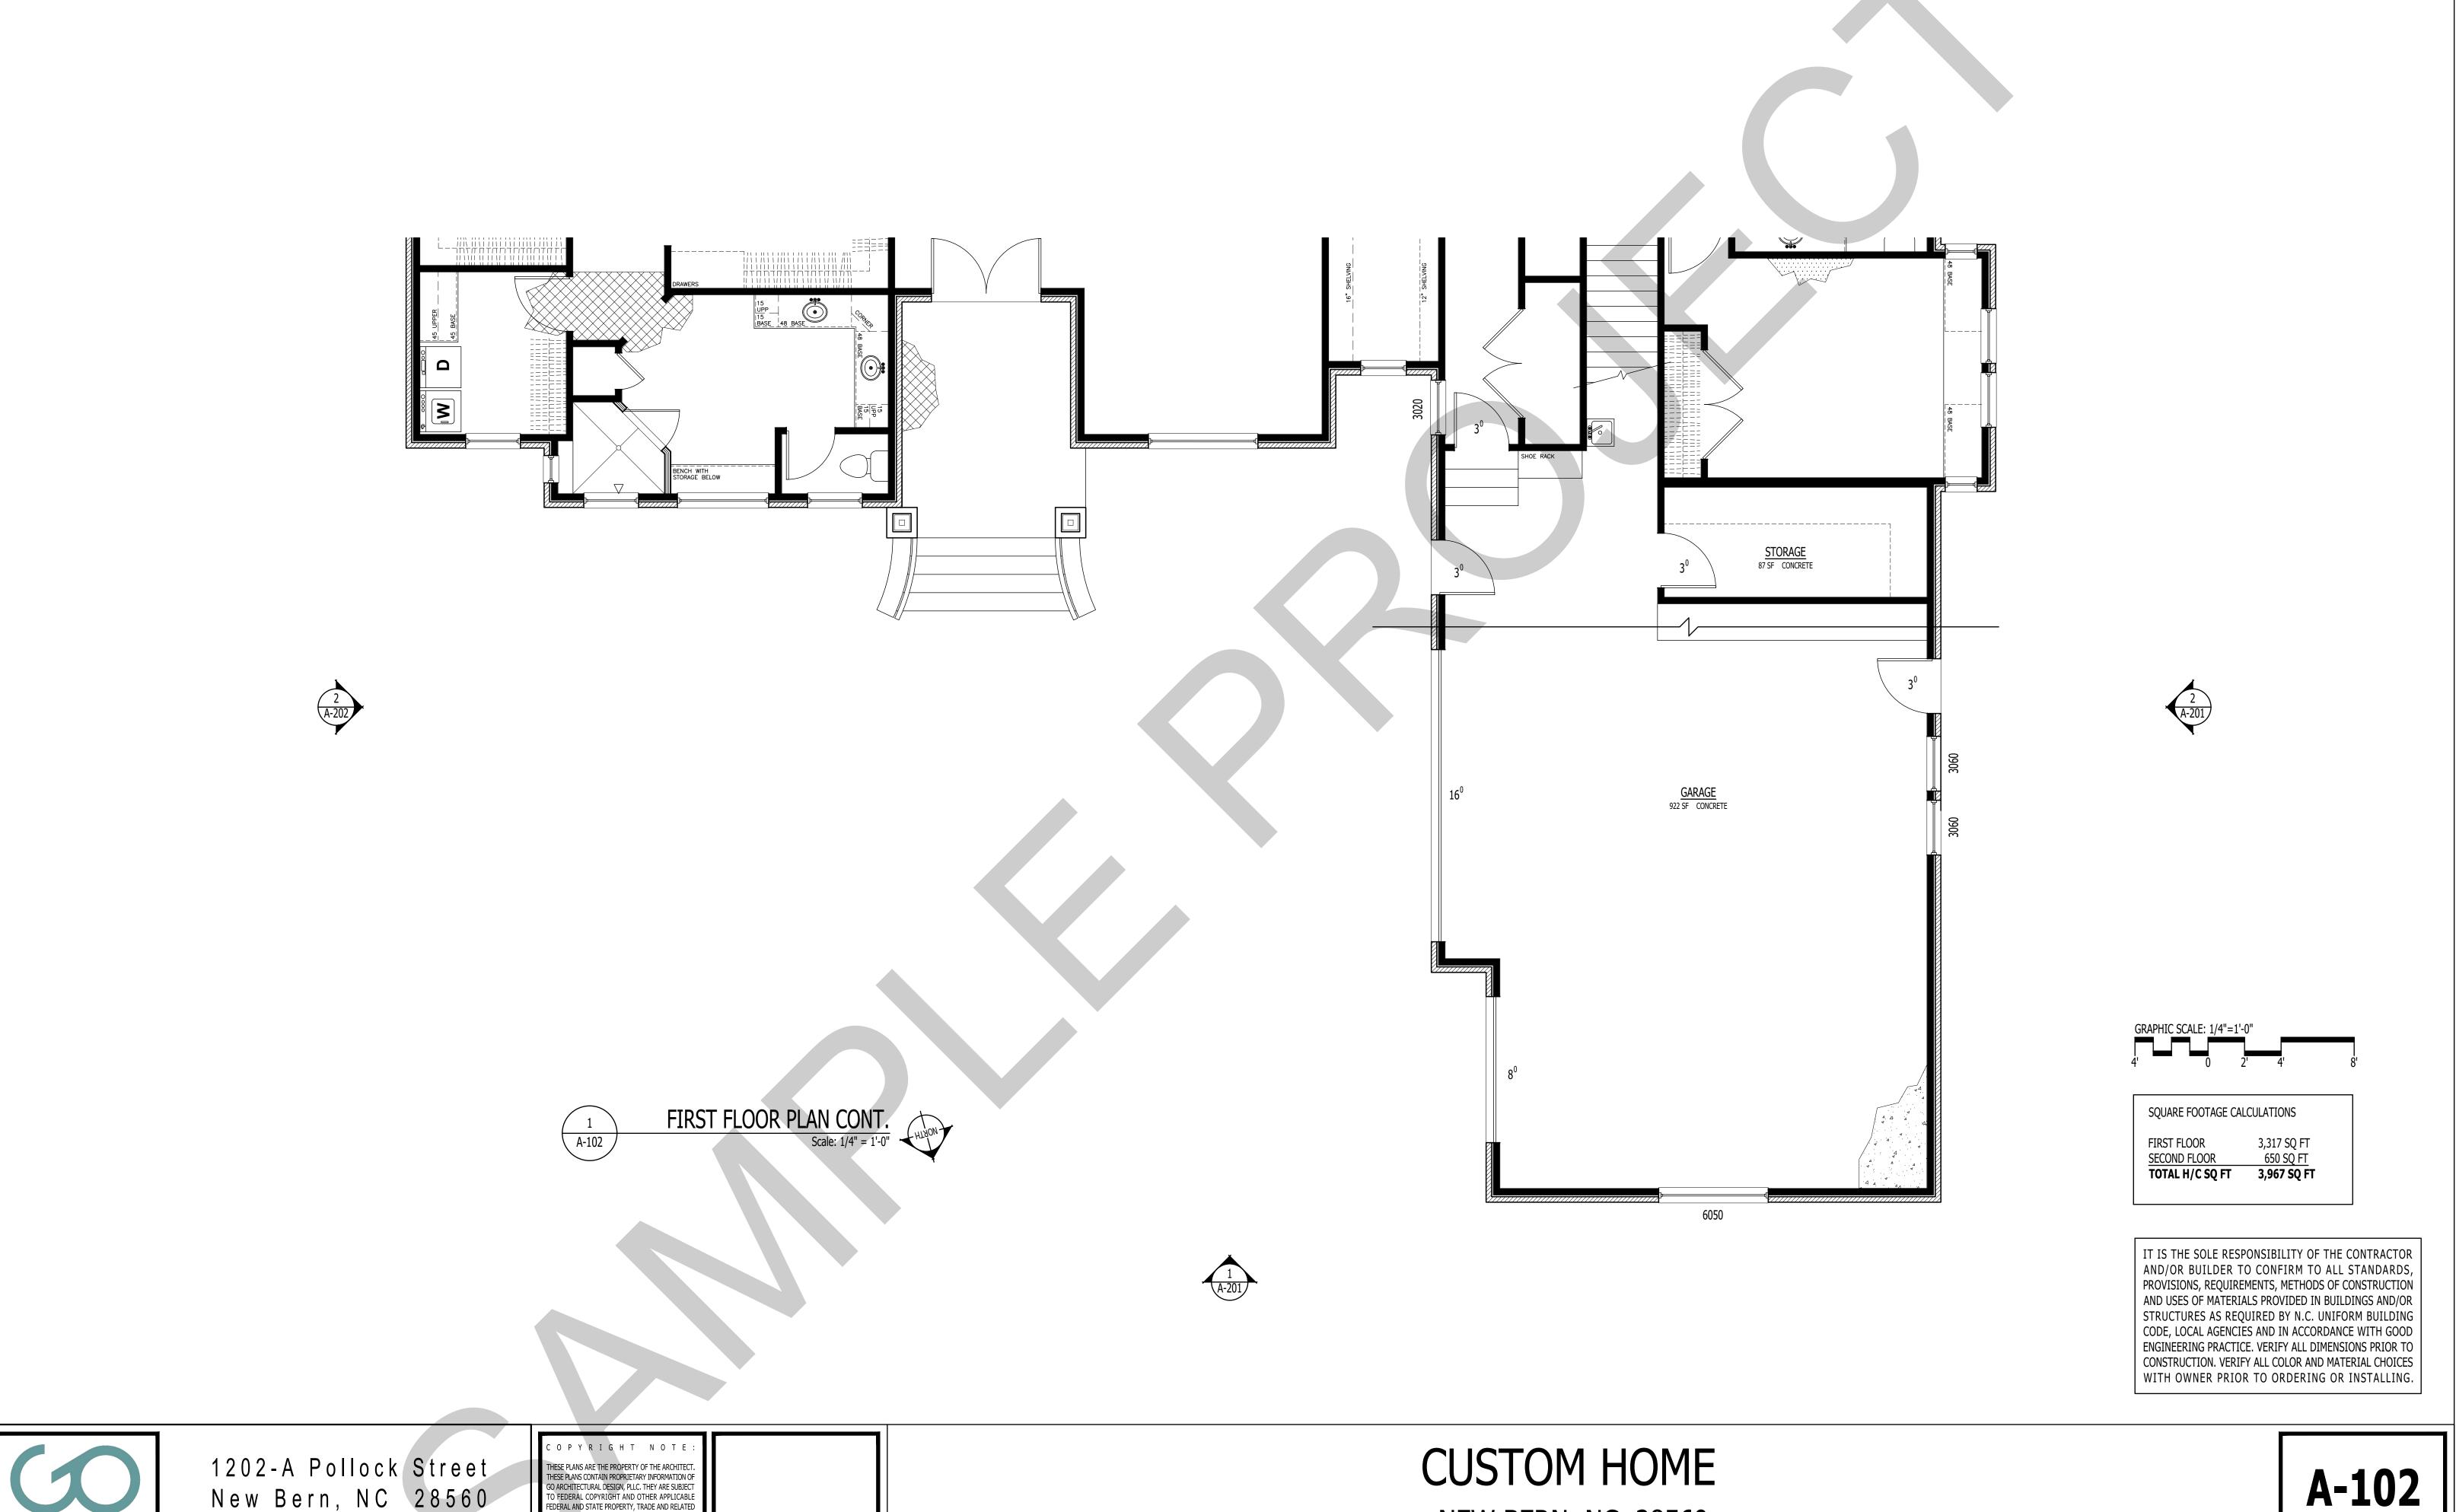


DESIGN


New Bern, NC 28560 2 5 2 - 6 3 3 - 0 3 2 2 www.goarchdesign.com

Revisions:

NEW BERN, NC 28560

FIRST FLOOR PLAN CONT

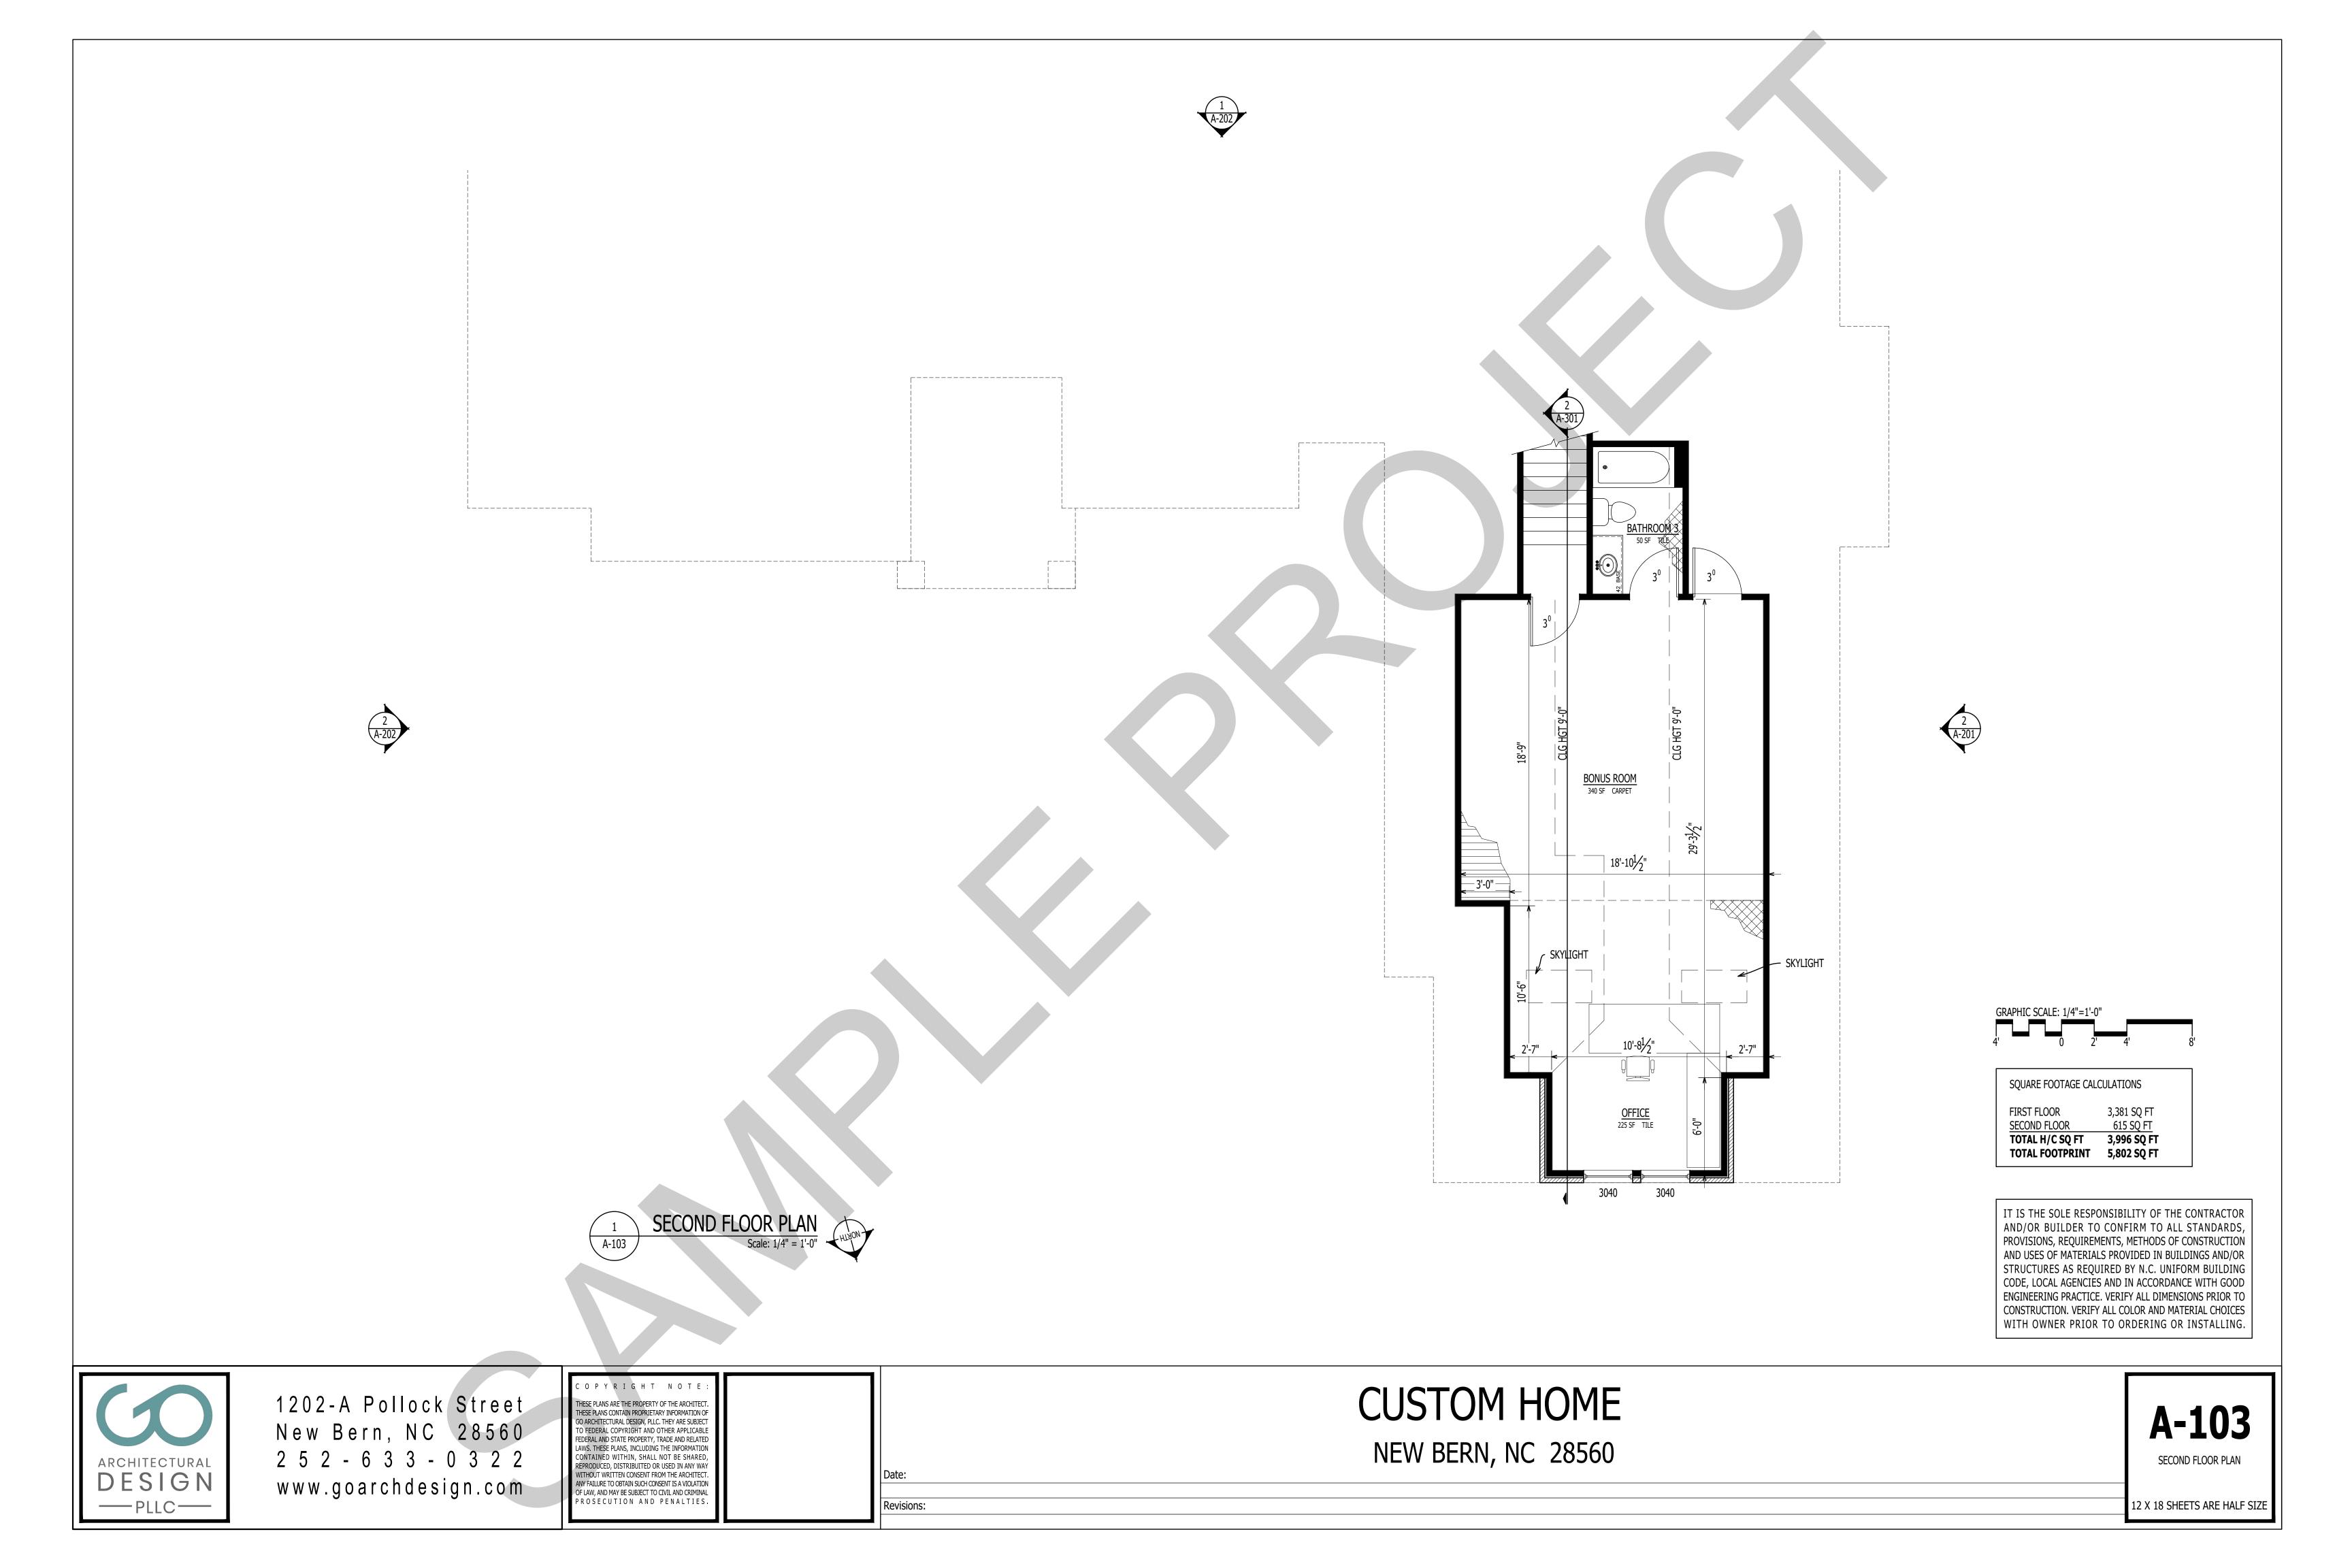

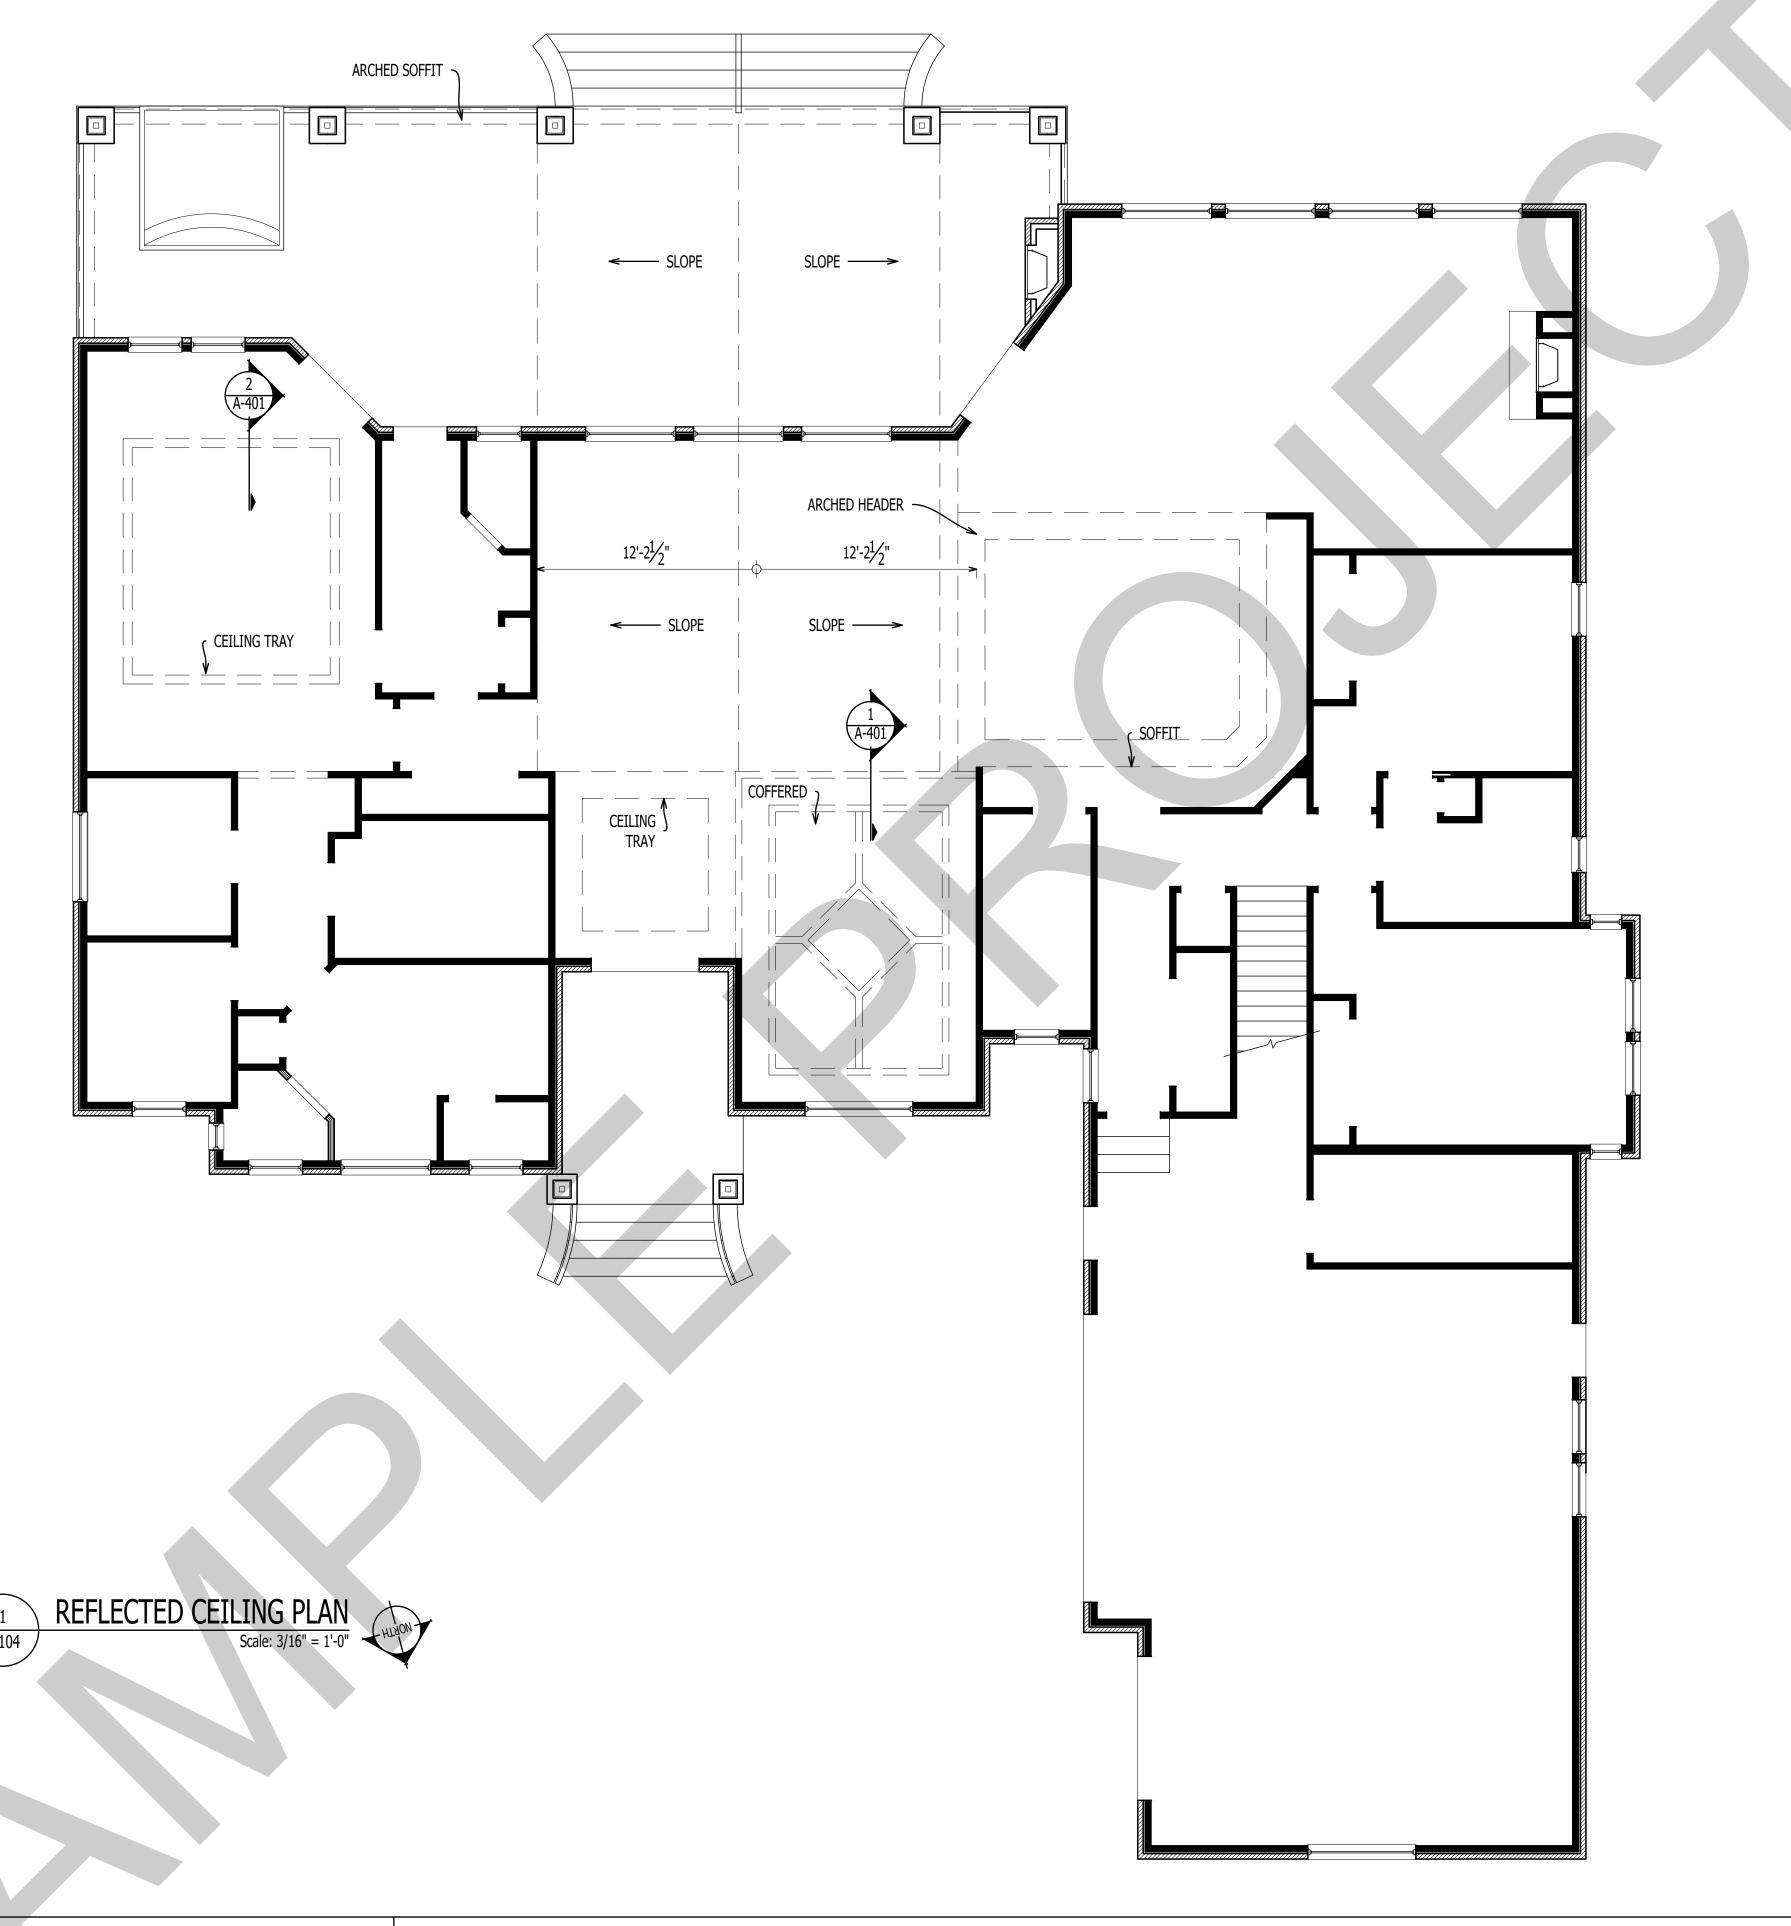

IT IS THE SOLE RESPONSIBILITY OF THE CONTRACTOR AND/OR BUILDER TO CONFIRM TO ALL STANDARDS, PROVISIONS, REQUIREMENTS, METHODS OF CONSTRUCTION AND USES OF MATERIALS PROVIDED IN BUILDINGS AND/OR STRUCTURES AS REQUIRED BY N.C. UNIFORM BUILDING CODE, LOCAL AGENCIES AND IN ACCORDANCE WITH GOOD ENGINEERING PRACTICE. VERIFY ALL DIMENSIONS PRIOR TO CONSTRUCTION. VERIFY ALL COLOR AND MATERIAL CHOICES WITH OWNER PRIOR TO ORDERING OR INSTALLING.



1202-A Pollock Street New Bern, NC 28560 2 5 2 - 6 3 3 - 0 3 2 2 www.goarchdesign.com


Revisions:

**CUSTOM HOME** 

NEW BERN, NC 28560

A-104

REFLECTED CEILING PLAN

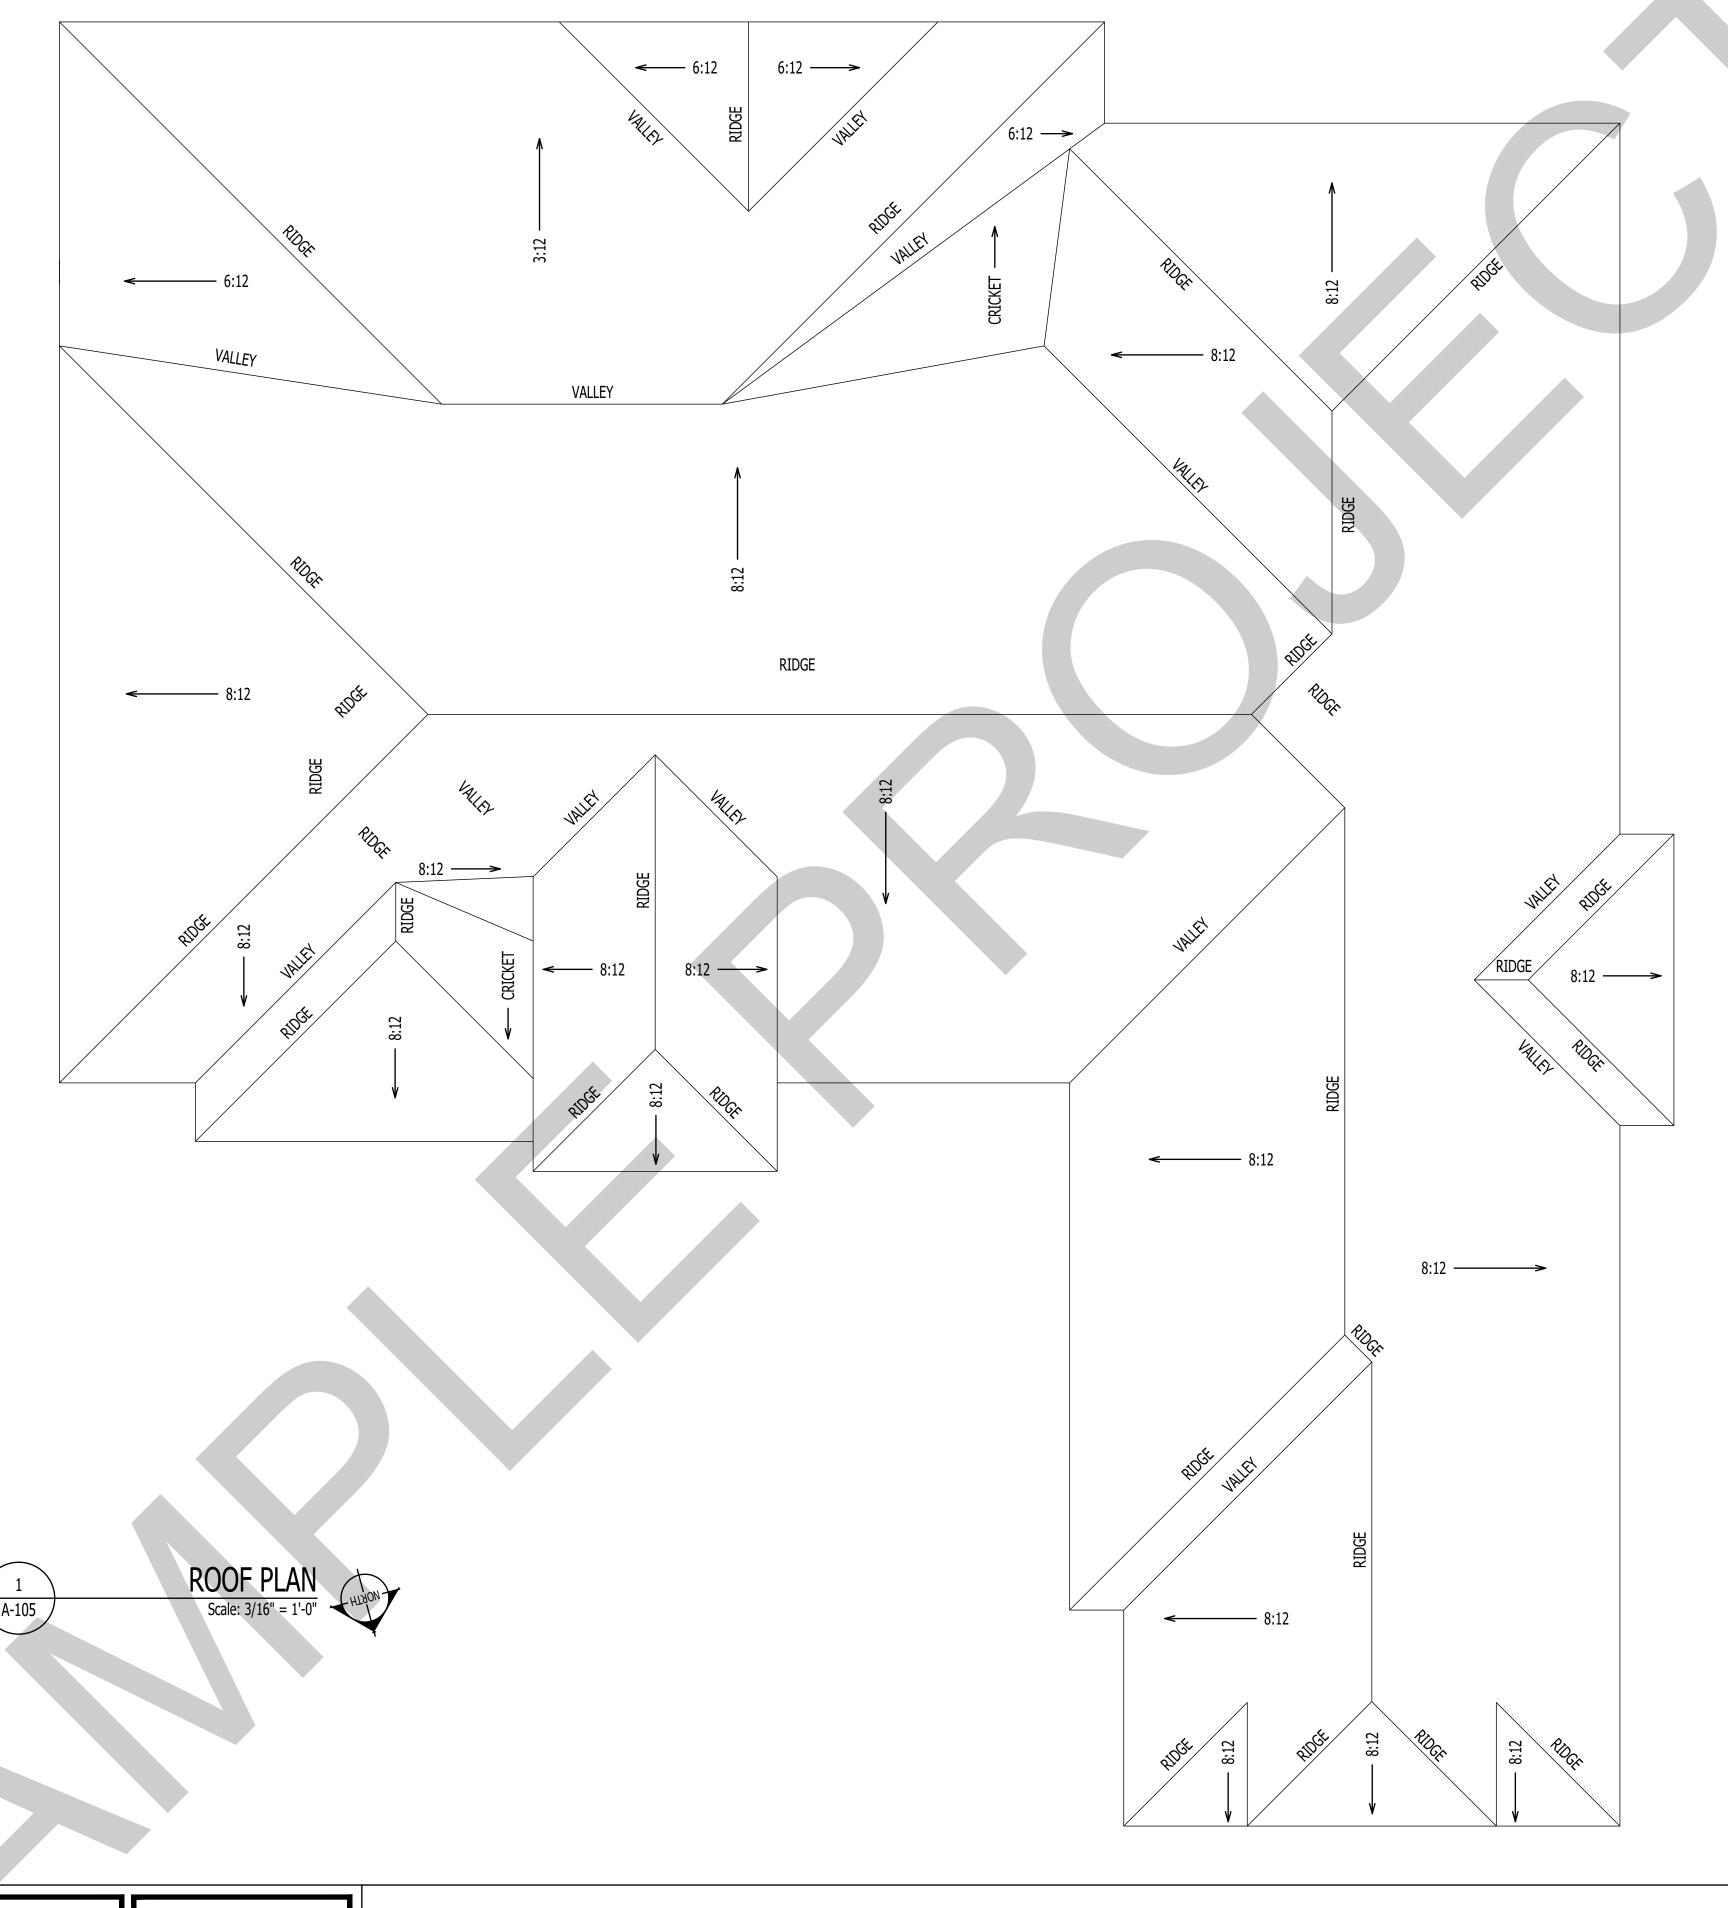

IT IS THE SOLE RESPONSIBILITY OF THE CONTRACTOR AND/OR BUILDER TO CONFIRM TO ALL STANDARDS, PROVISIONS, REQUIREMENTS, METHODS OF CONSTRUCTION AND USES OF MATERIALS PROVIDED IN BUILDINGS AND/OR STRUCTURES AS REQUIRED BY N.C. UNIFORM BUILDING CODE, LOCAL AGENCIES AND IN ACCORDANCE WITH GOOD ENGINEERING PRACTICE. VERIFY ALL DIMENSIONS PRIOR TO CONSTRUCTION. VERIFY ALL COLOR AND MATERIAL CHOICES WITH OWNER PRIOR TO ORDERING OR INSTALLING.



1202-A Pollock Street New Bern, NC 28560 2 5 2 - 6 3 3 - 0 3 2 2 www.goarchdesign.com


Revisions:


**CUSTOM HOME** 


NEW BERN, NC 28560


A-105

ROOF PLAN

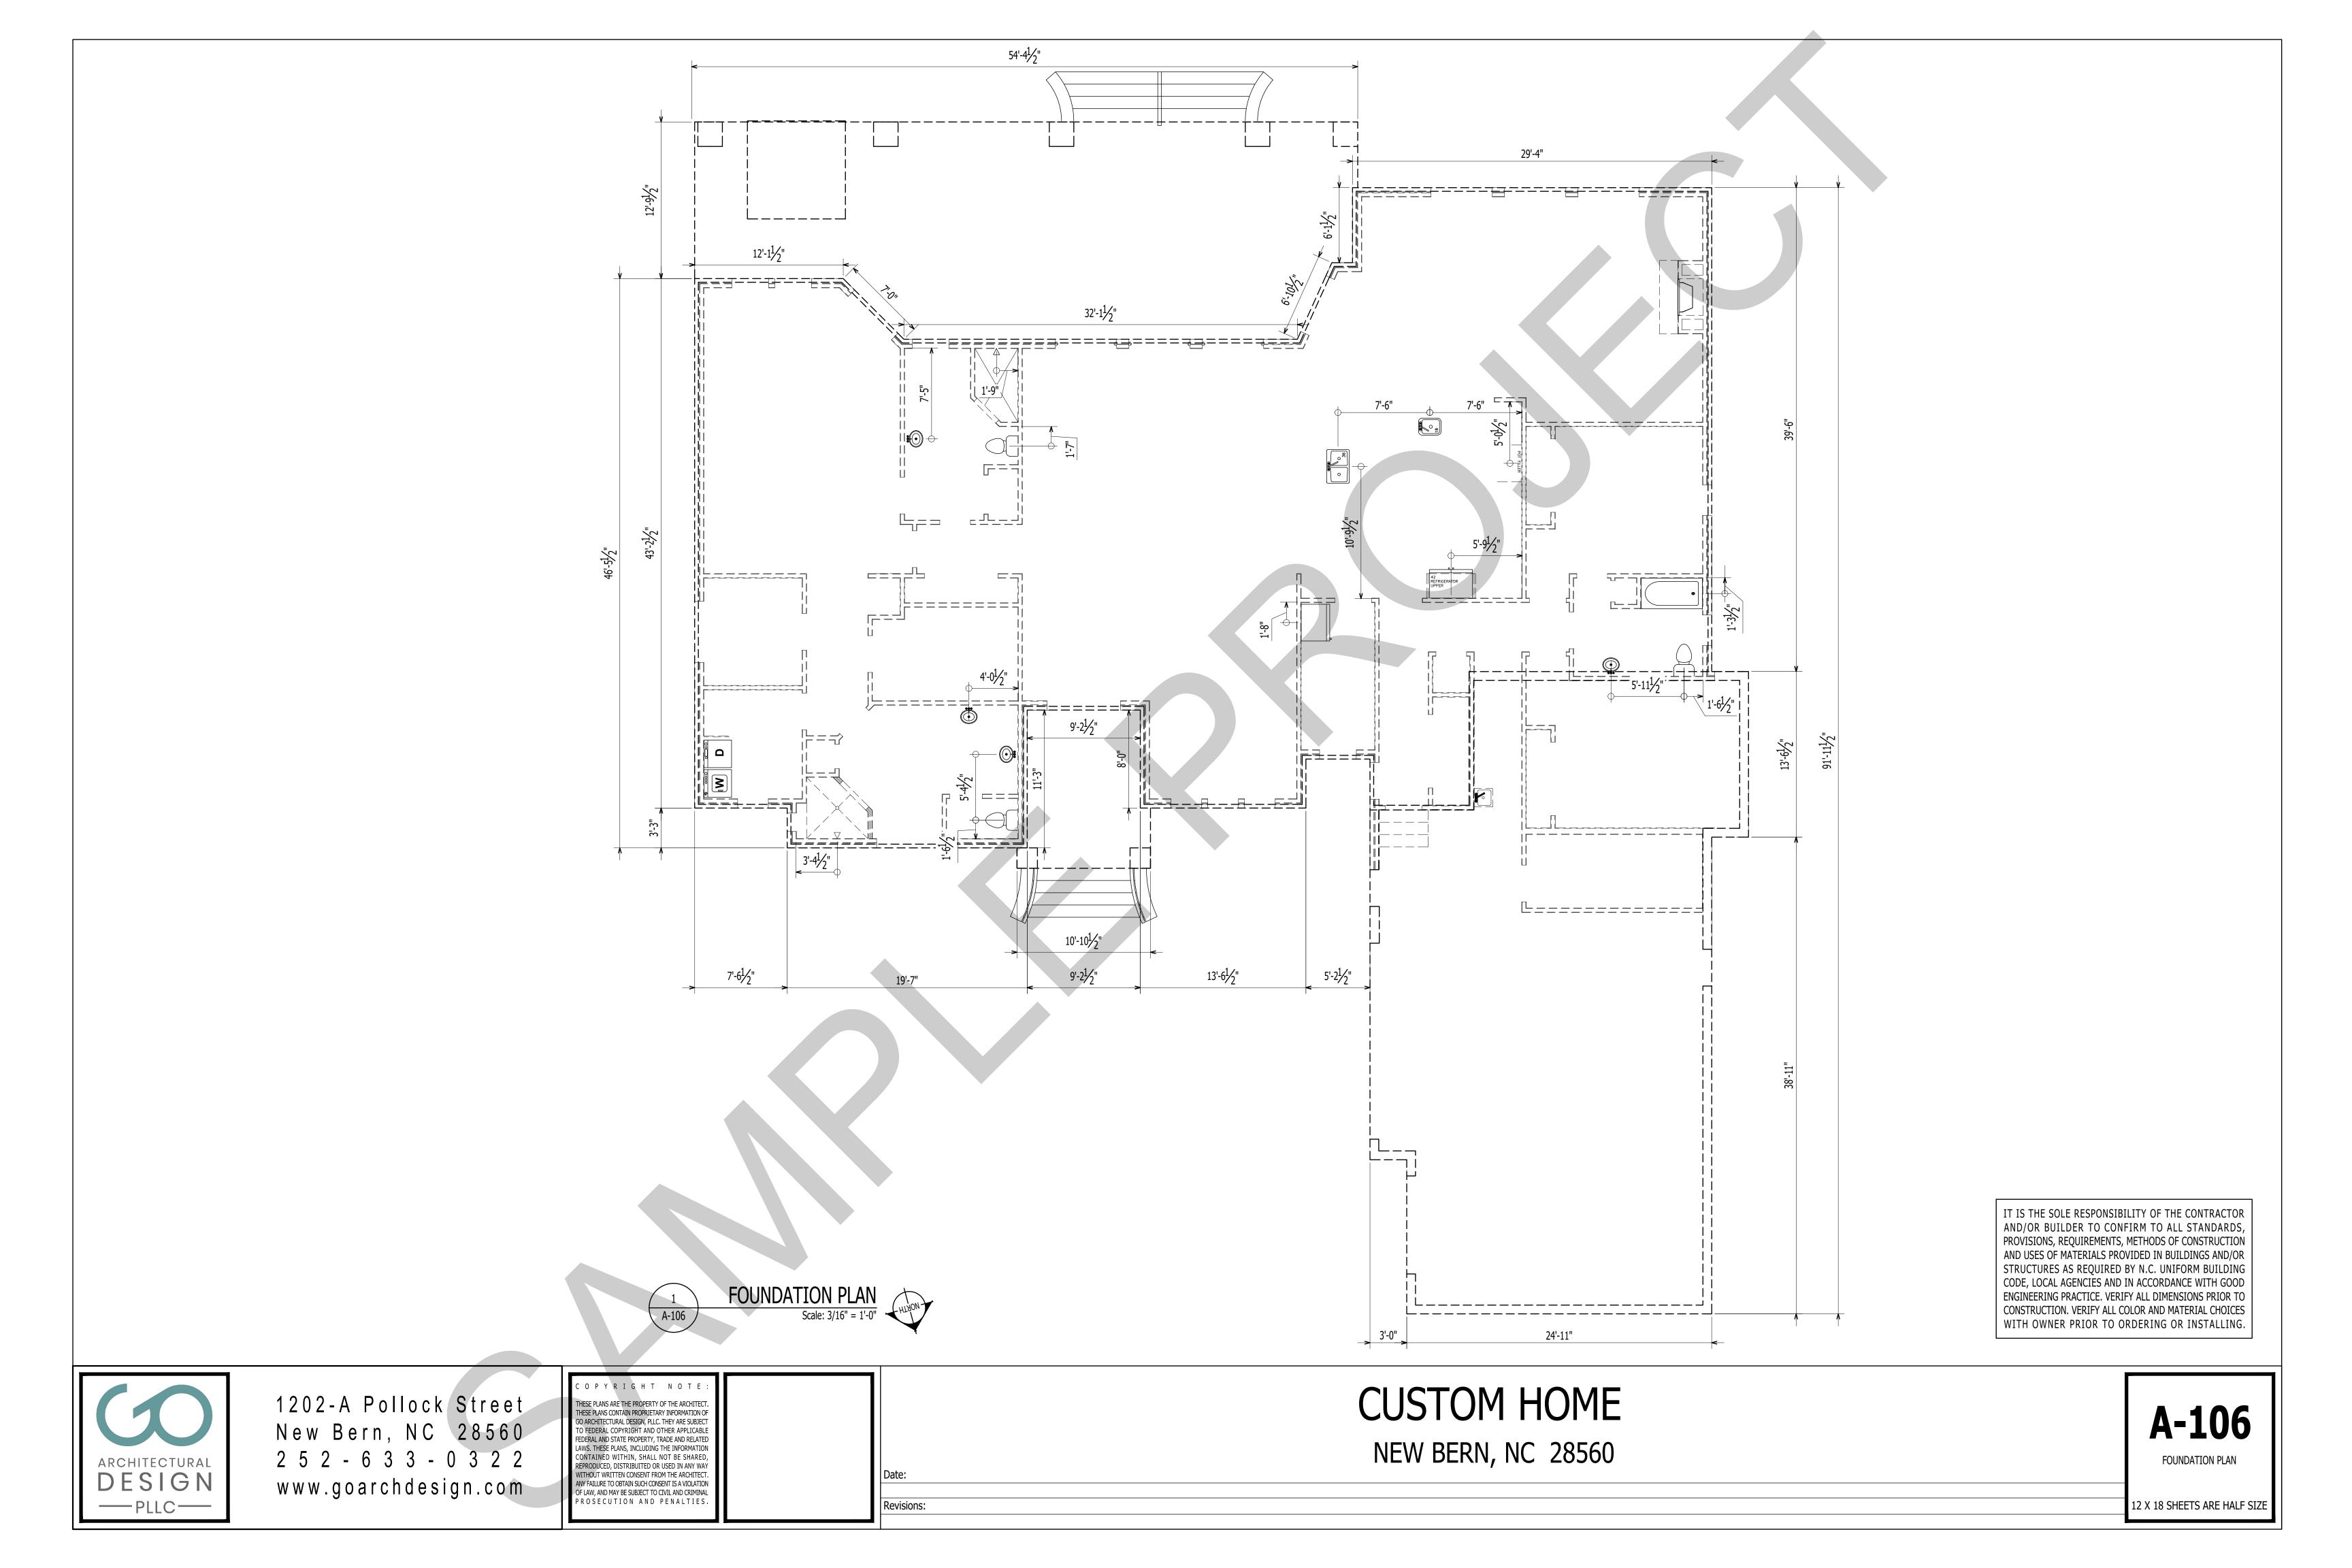

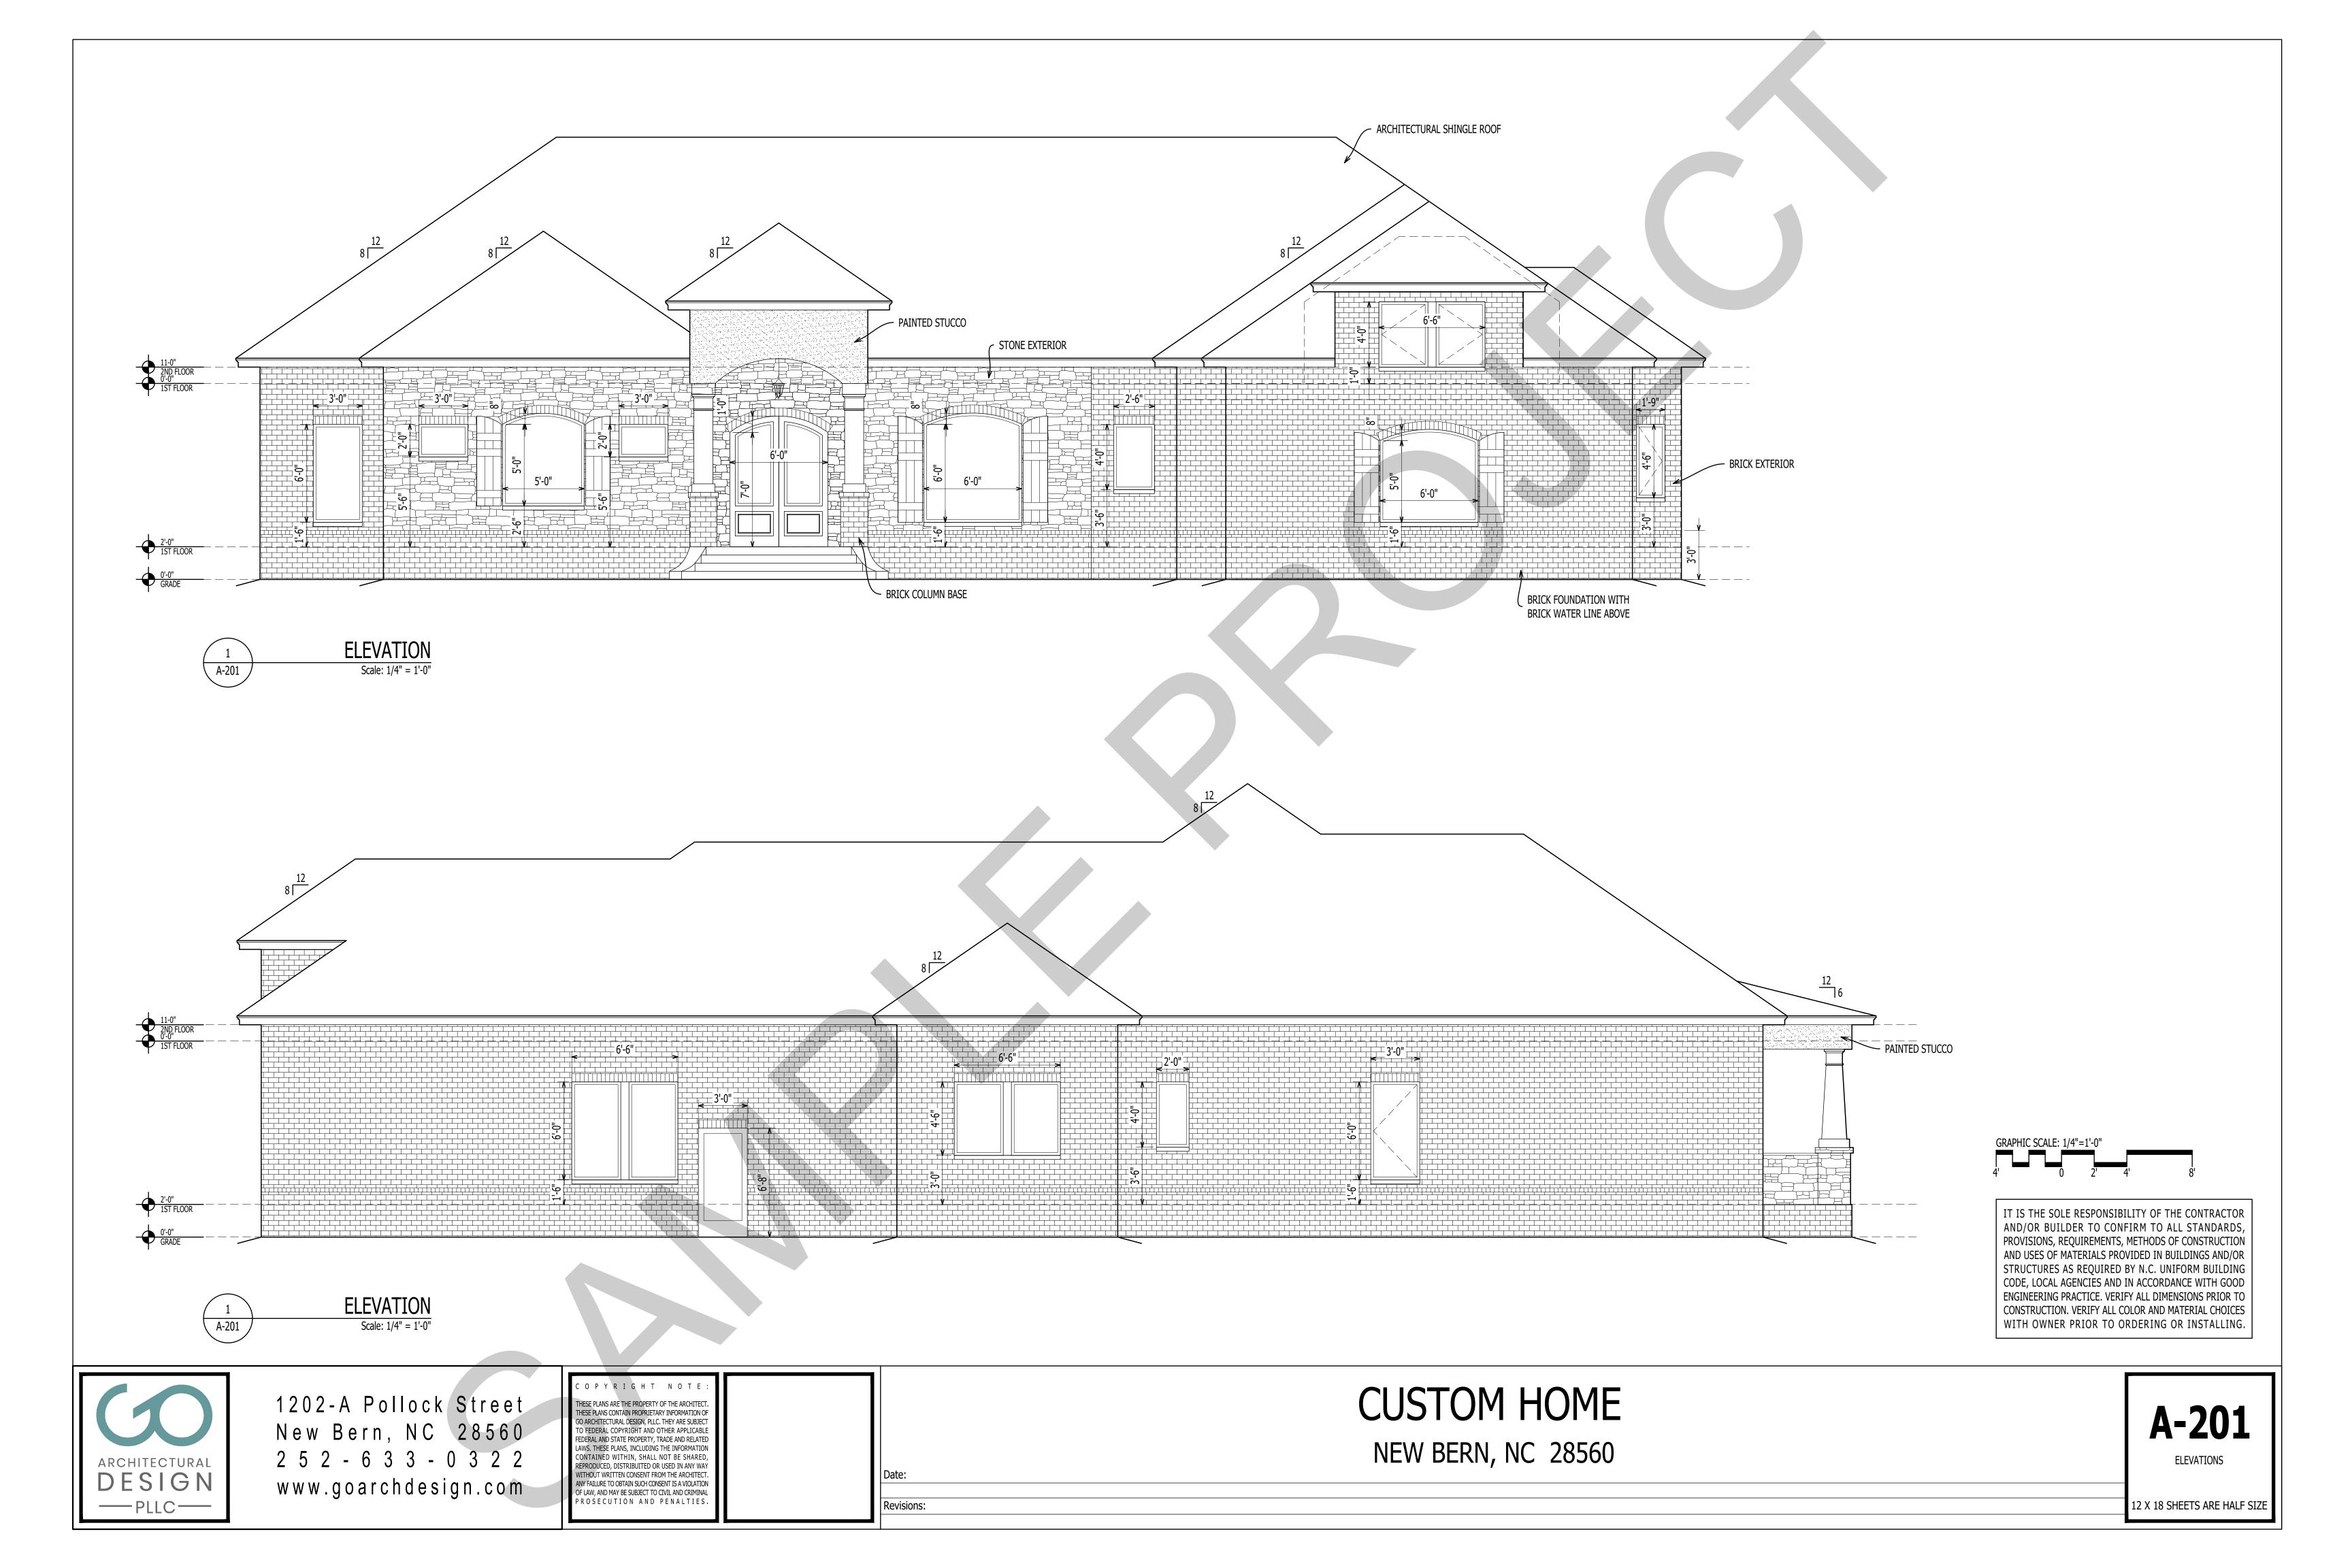

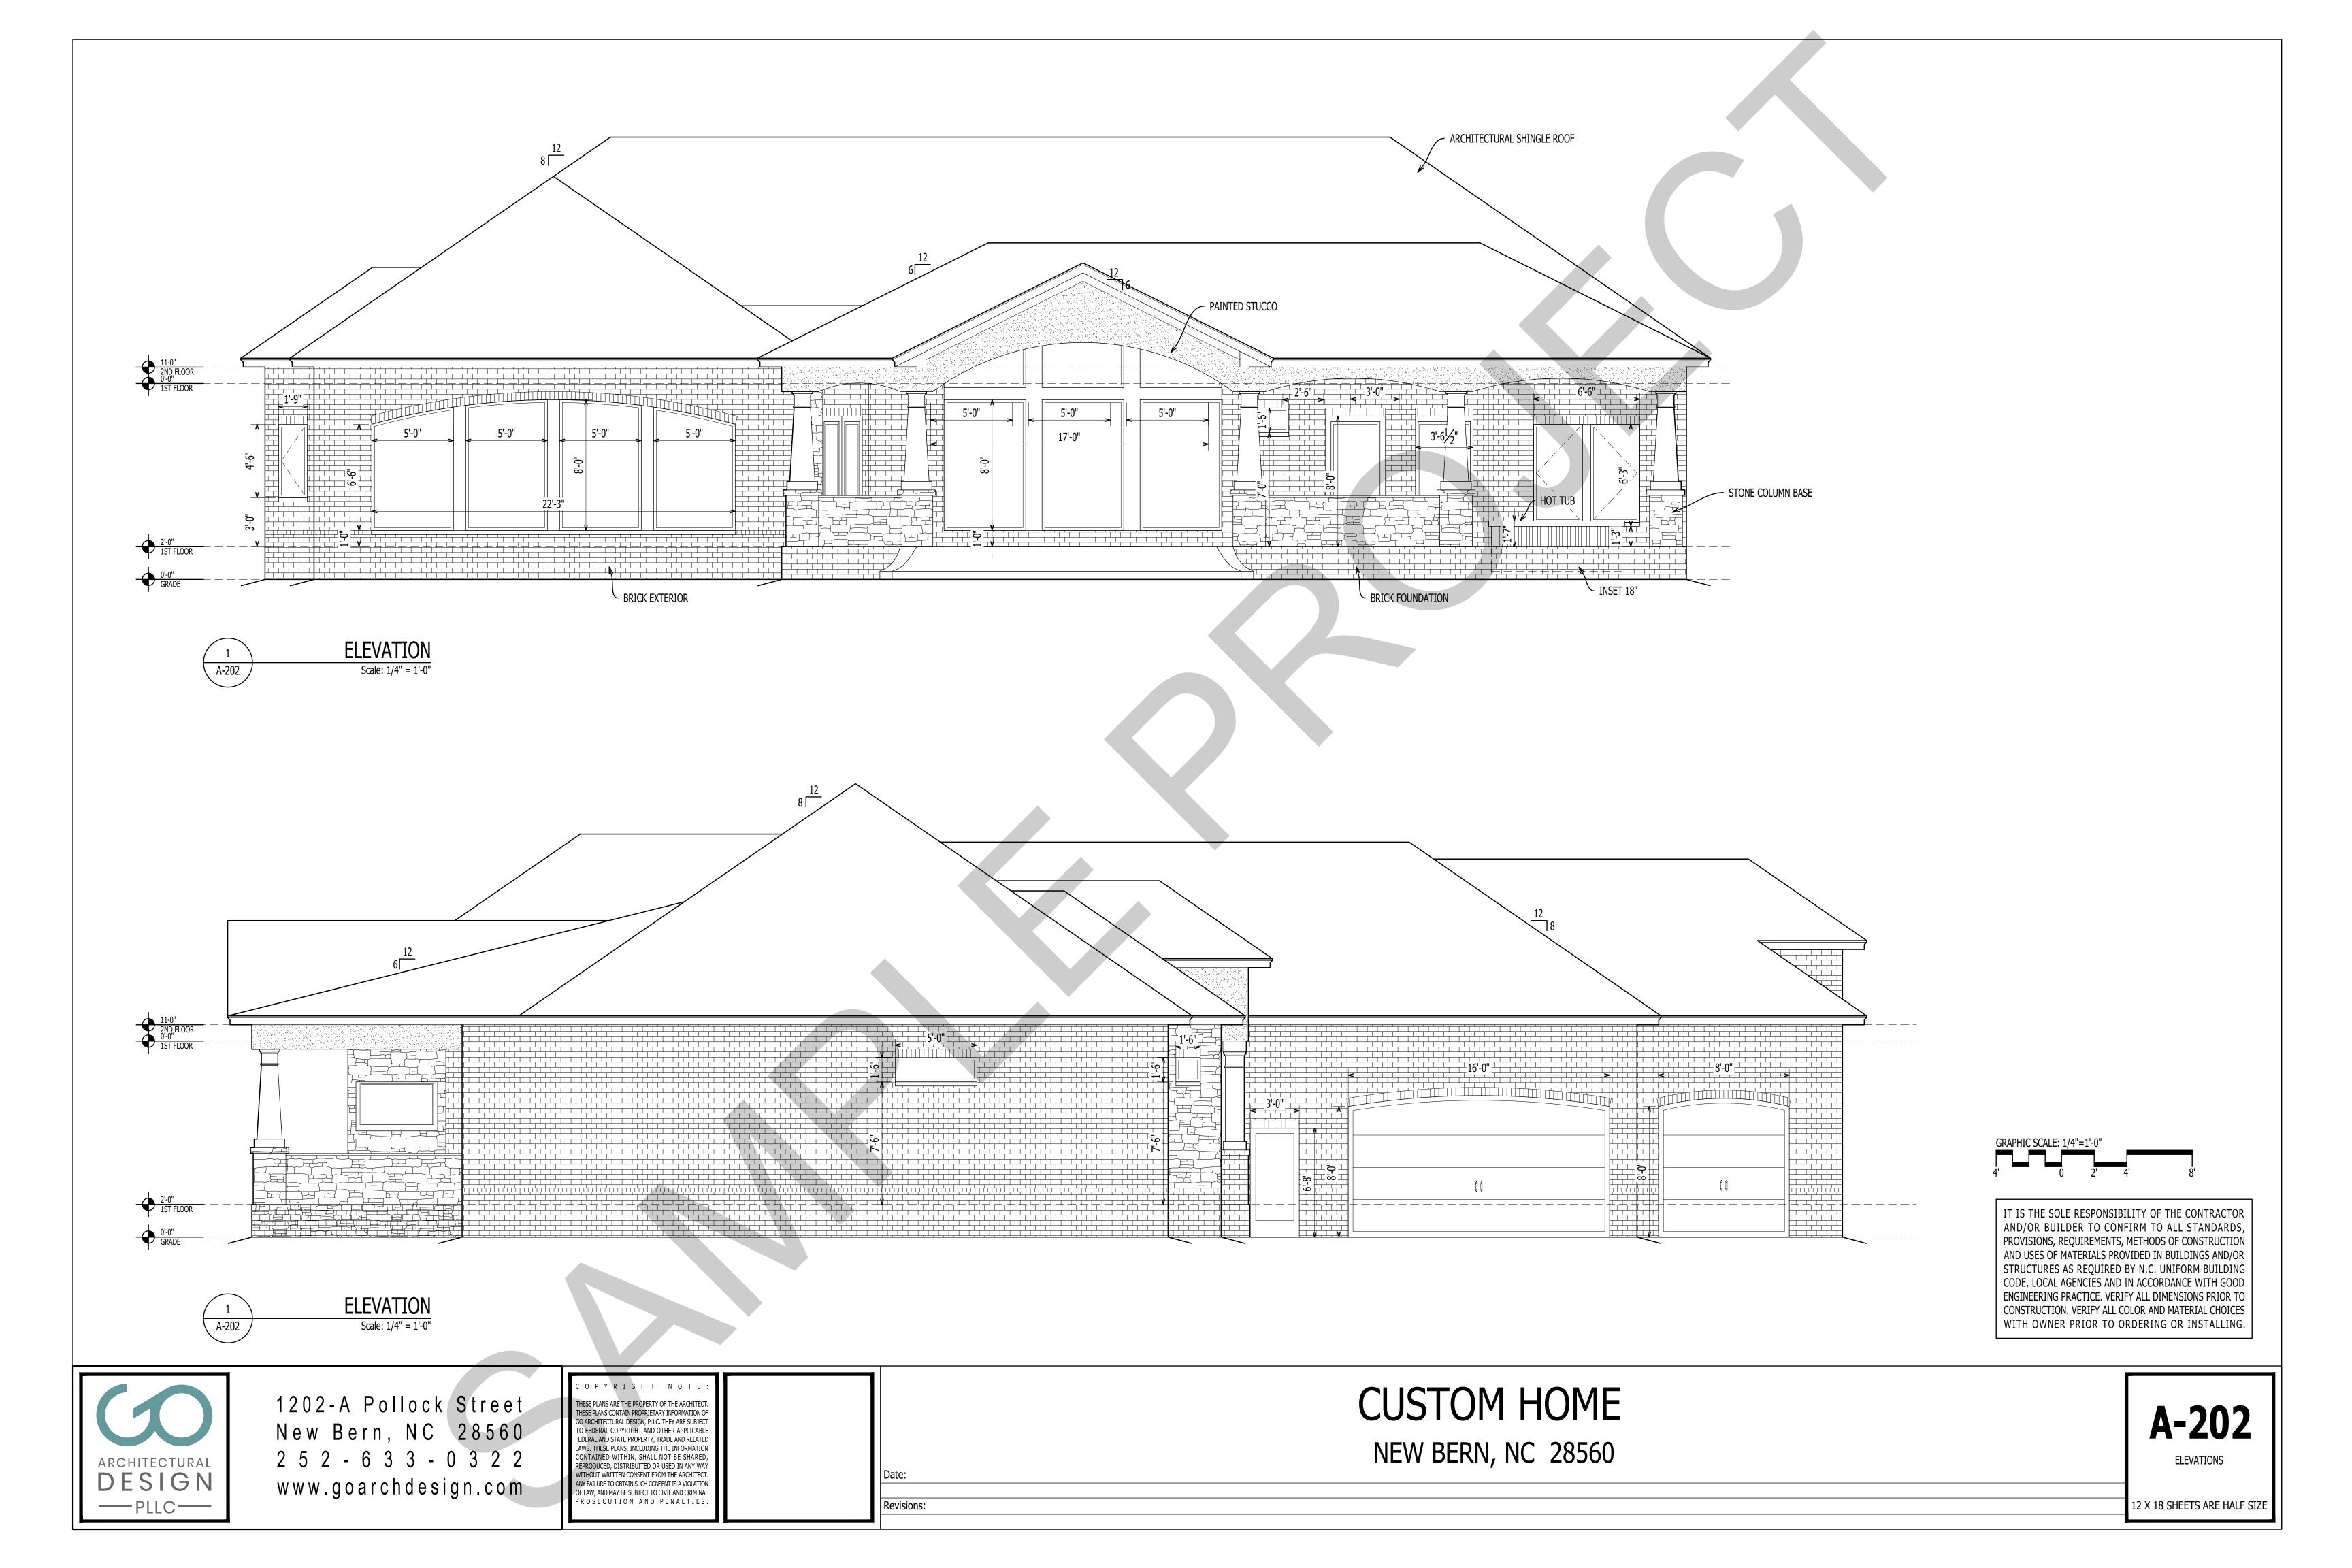

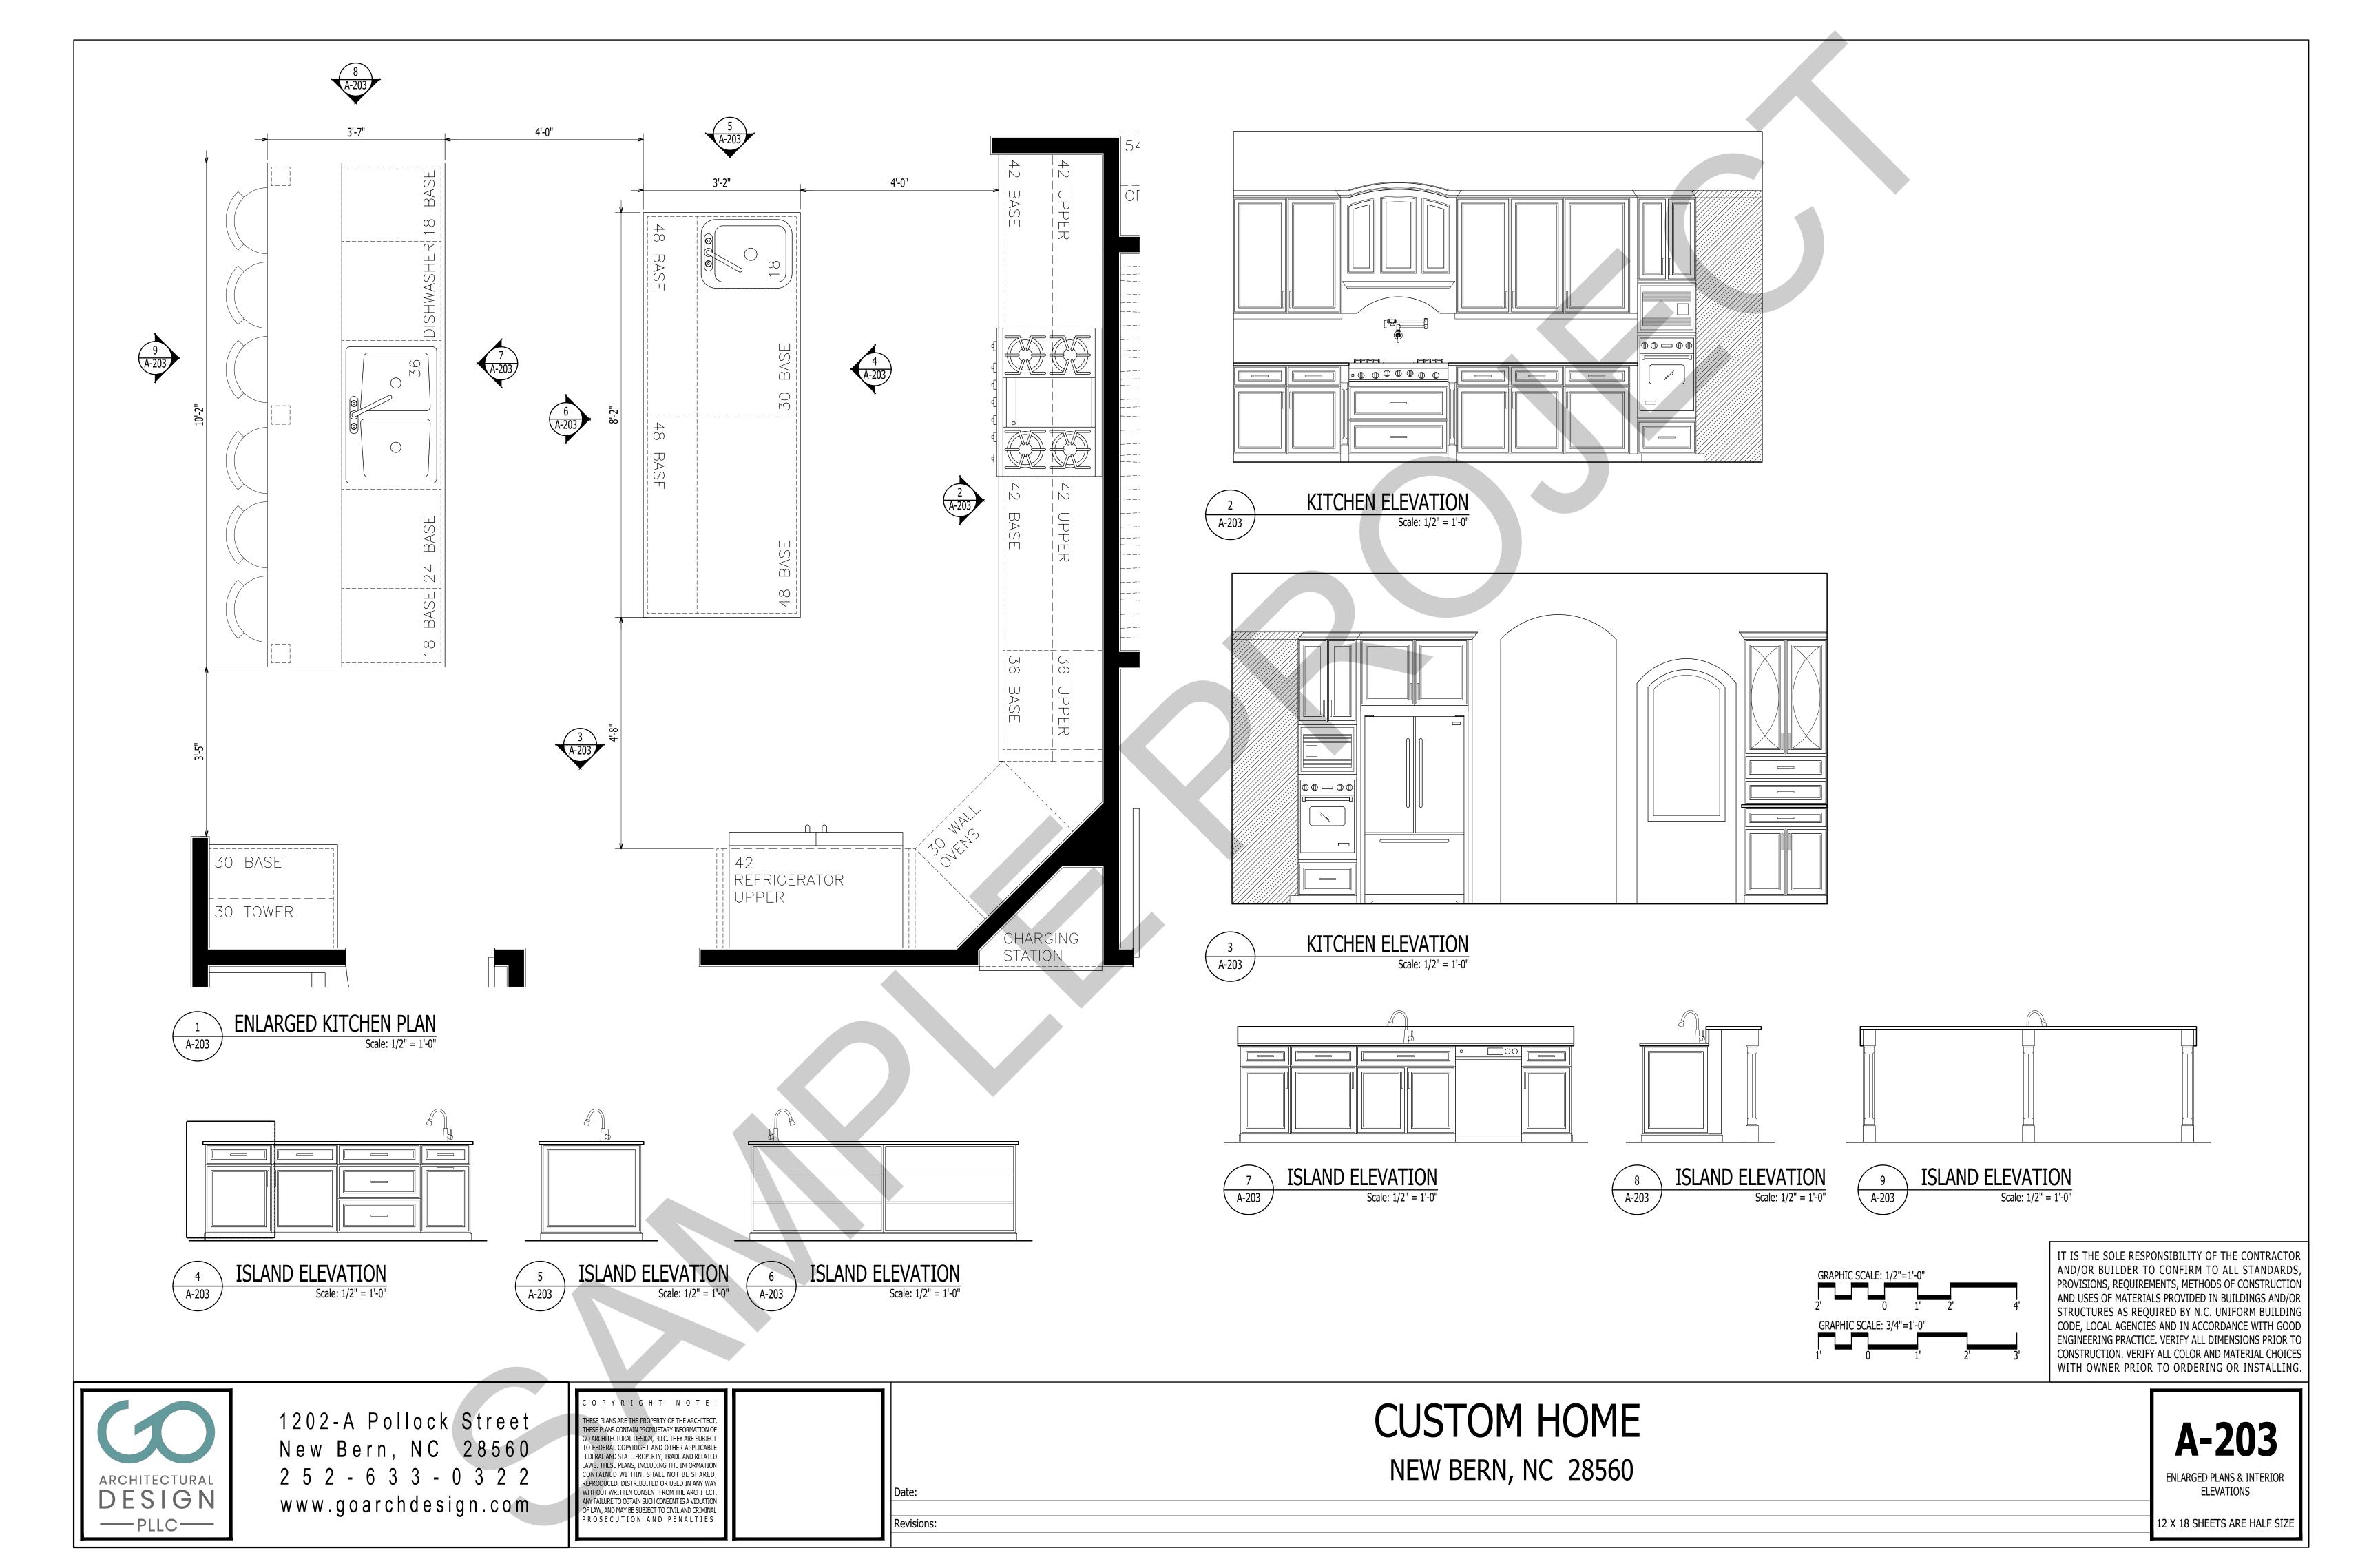











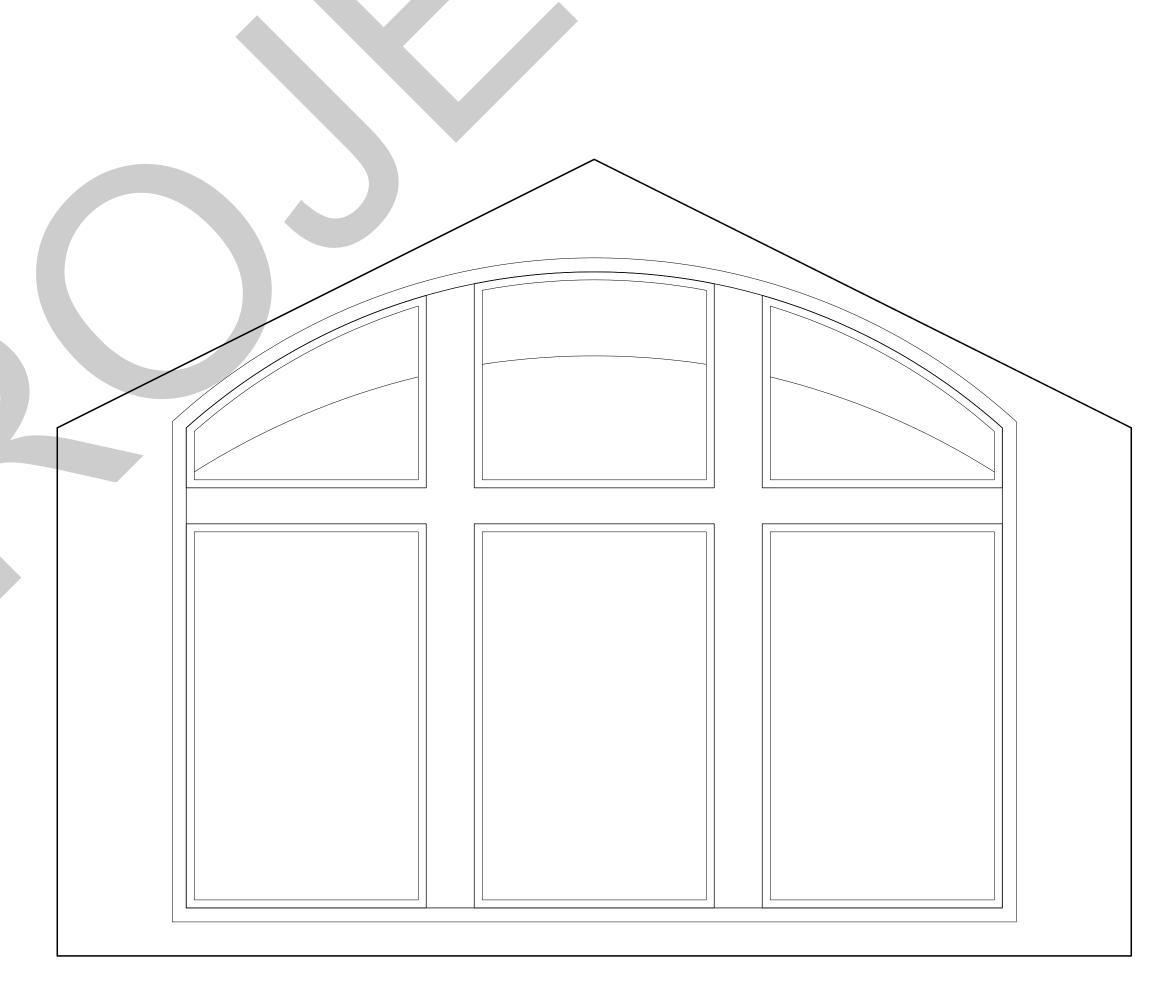

INTERIOR ELEVATION Scale: 1/2" = 1'-0"

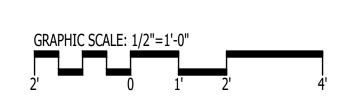

IT IS THE SOLE RESPONSIBILITY OF THE CONTRACTOR AND/OR BUILDER TO CONFIRM TO ALL STANDARDS, PROVISIONS, REQUIREMENTS, METHODS OF CONSTRUCTION AND USES OF MATERIALS PROVIDED IN BUILDINGS AND/OR STRUCTURES AS REQUIRED BY N.C. UNIFORM BUILDING CODE, LOCAL AGENCIES AND IN ACCORDANCE WITH GOOD ENGINEERING PRACTICE. VERIFY ALL DIMENSIONS PRIOR TO CONSTRUCTION. VERIFY ALL COLOR AND MATERIAL CHOICES WITH OWNER PRIOR TO ORDERING OR INSTALLING.



1202-A Pollock Street New Bern, NC 28560 2 5 2 - 6 3 3 - 0 3 2 2 www.goarchdesign.com

THESE PLANS ARE THE PROPERTY OF THE ARCHITECT. THESE PLANS CONTAIN PROPRIETARY INFORMATION OF GO ARCHITECTURAL DESIGN, PLLC. THEY ARE SUBJECT TO FEDERAL COPYRIGHT AND OTHER APPLICABLE FEDERAL AND STATE PROPERTY, TRADE AND RELATED LAWS. THESE PLANS, INCLUDING THE INFORMATION CONTAINED WITHIN, SHALL NOT BE SHARED, REPRODUCED, DISTRIBUITED OR USED IN ANY WAY WITHOUT WRITTEN CONSENT FROM THE ARCHITECT. ANY FAILURE TO OBTAIN SUCH CONSENT IS A VIOLATION OF LAW, AND MAY BE SUBJECT TO CIVIL AND CRIMINAL PROSECUTION AND PENALTIES.


Revisions:


CUSTOM HOME

NEW BERN, NC 28560

**A-204** 


ENLARGED PLANS & INTERIOR ELEVATIONS

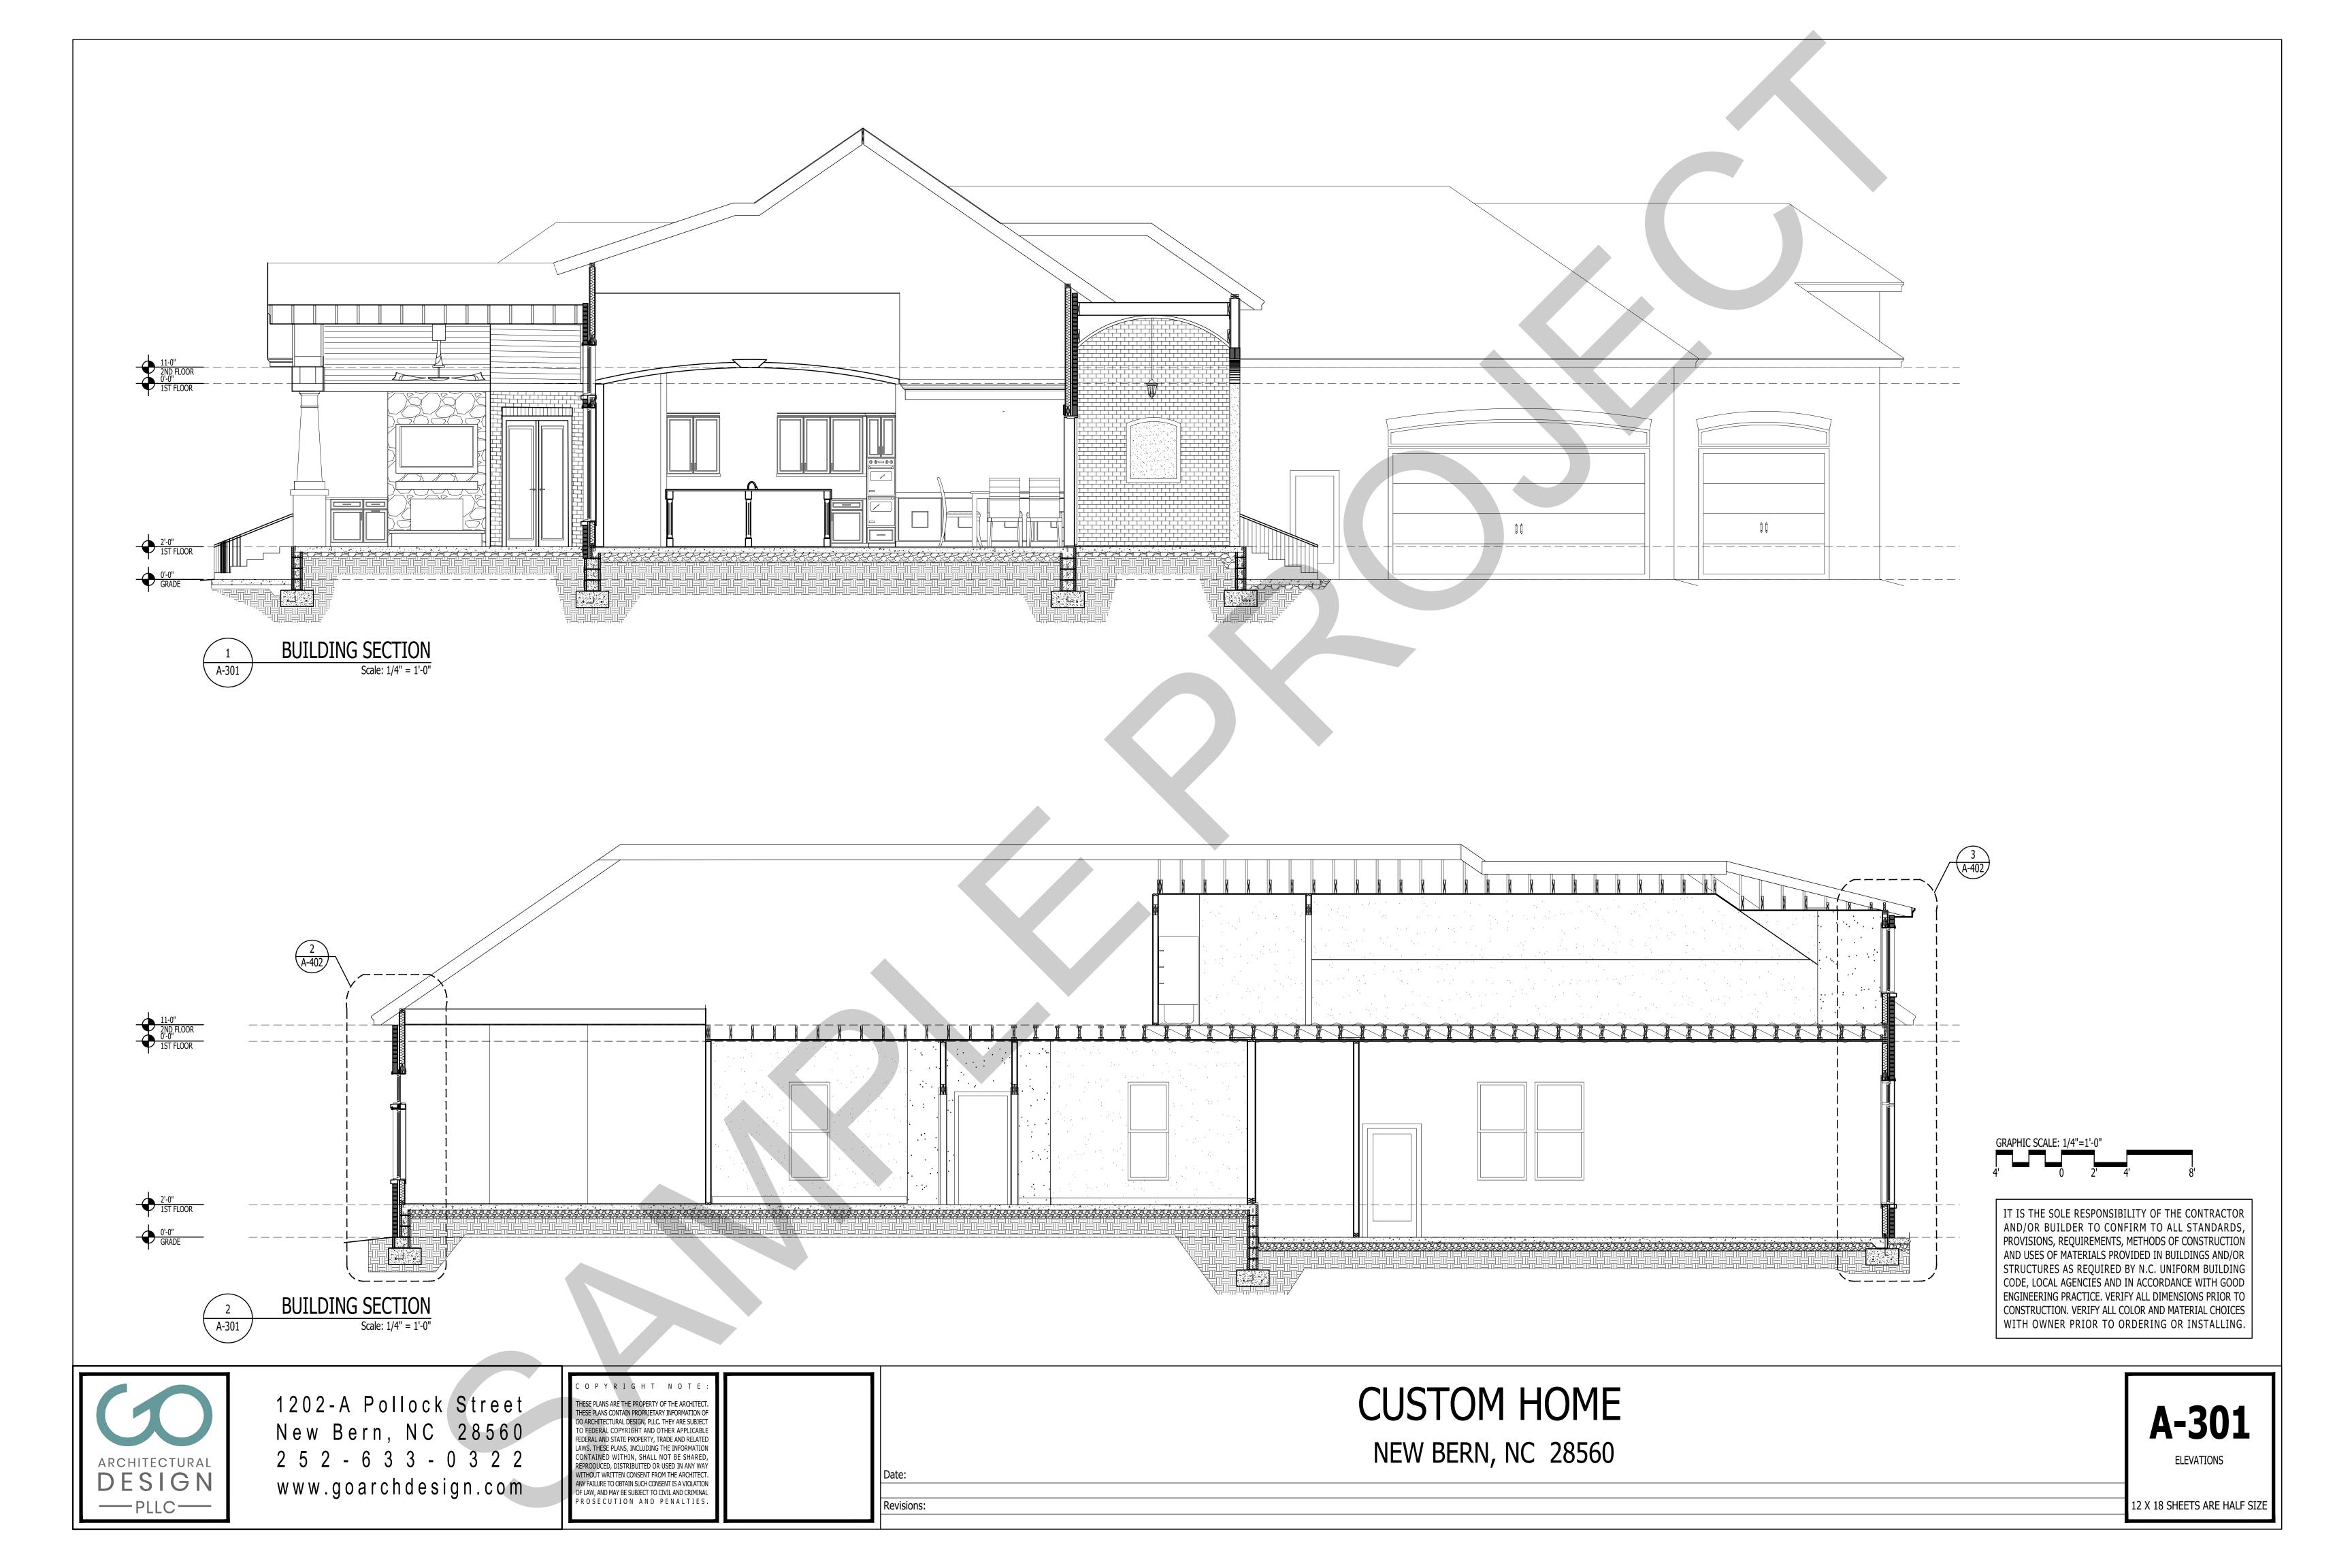


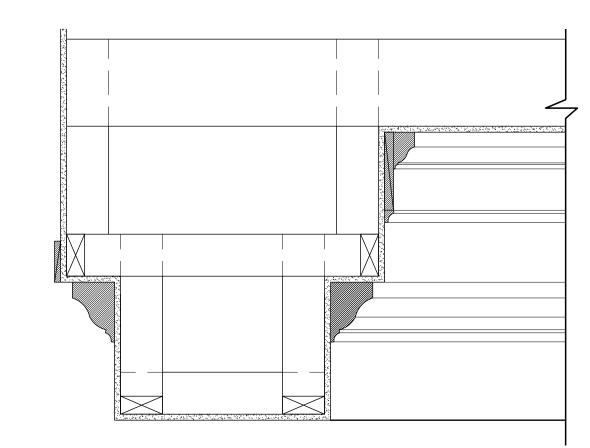




### CEILING SECTION- DINING RM Scale: 1 1/2" = 1'-0"

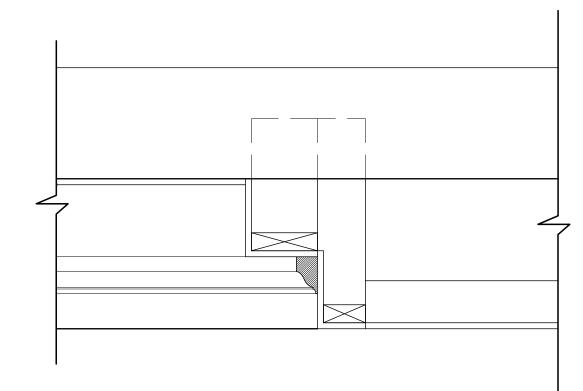


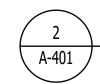

CEILING SECTION- MASTER BED RM

Scale: 1 1/2" = 1'-0"

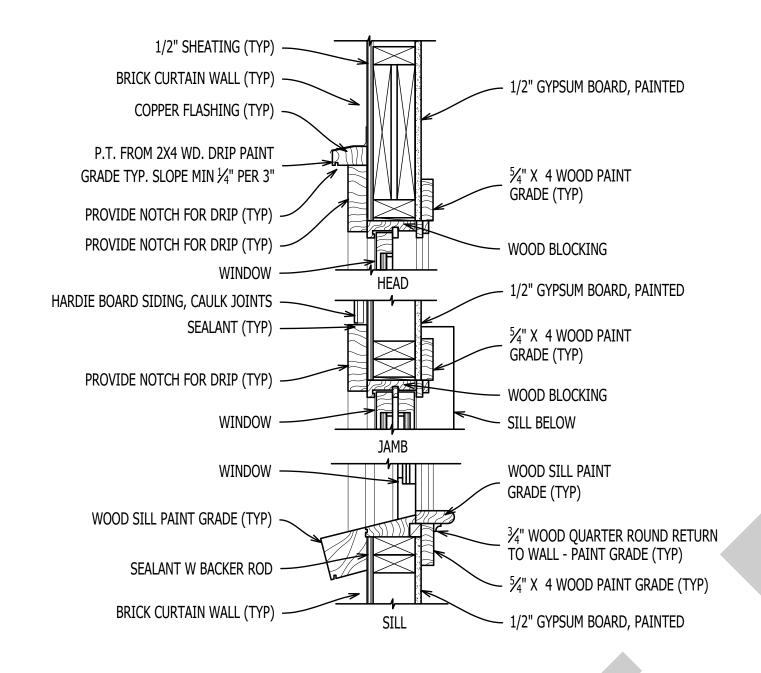

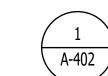

WINDOW SECTION

Scale: 1-1/2" = 1'-0"

Revisions:

DESIGN CRITERIA:

DESIGN WIND SPEED = 120mph, EXPOSURE CATEGORY 'C',

ENCLOSED BUILDING

DESIGN LIVE LOADS: FLOOR=40psf, ROOF=20psf

MASONRY NOTES:

ALL MASONRY SHALL BE LAID IN A RUNNING BOND PATTERN.

CONCRETE MASONRY UNITS SHALL BE CELLULAR UNITS CONFORMING TO ASTM C90 GRADE N-2.

STRUCTURAL BRICK SHALL CONFORM TO ASTM C62

BRICK & CRICK SHALL HAVE MINIMUM COMPRESSIVE STRENGTH = 1,500psi

MORTAR SHALL BE TYPE 'S' AND CONFORM TO ASTM C270

DO NOT APPLY UNIFORM LOADS TO MASONRY UNTIL AT LEAST 12HRS AFTER BUILDING WALLS. DO NOT APPLY CONCENTRATED LOADS UNTIL AT LEAST 3 DAYS AFTER BUILDING WALLS.

SITE CONDITIONS ARE UNKNOWN. FOUNDATION AND FOOTING DESIGN BASED ON PRESUMPTIVE SOIL BEARING PRESSURE OF 2000psf. CONTRACTOR SHALL CONFIRM.

STRUCTURAL FILL SHALL BE PLACES IN LIFTS OF NOT MORE THAN 6-in. LOOSE THICKNESS, WITH EACH LIFT COMPACTED TO AT LEAST 95% OF ITS MAXIMUM STANDARD PROCTOR DENSITY

WOOD FRAMING NOTES:

LUMBER SHALL BE SOUTHERN YELLOW PINE (SYP) #2 OR BETTER FOR HEADERS, JOISTS, AND RAFTERS UNO. STUDS, BRACING, AND BLOCKING SHALL BE SPRUCE PINE FIR (SPF) #2 OR BETTER.

# - DENOTES NU,BER OF JACK STUDS REQUIRED (2 UNLESS NOTED OTHERWISE)

LAMINATED VENEER LUMBER (LVL) PILES SHALL BE 1.75" WIDE AND MEET OR EXCEED THE FOLLOWING DESIGN PROPERTIES:

MODULES OF ELASTICITY (E) - 1,800,000 psi FLEXURAL STRESS (Fb) - 2,400 psi SHEAR STRESS (FV) - 190 psi

LBW - LOAD BEARING WALL

FLUSH - BOTTOM OF HEADER IS FLUSH w/ BOTTOM OF FLOOR SYSTEM

ALL PRESSURE TREATED 2x\_MATERIAL SHALL BE SYP #2 OR BETTER

EXTERIOR WALLS SHALL BE SHEATHED WITH  $\frac{7}{16}$ " OSB (24/16 APA RATED SHEATHING) AND NAILED WITH 8d NAILS 3" O.C. AT ALL PANEL EDGES AND 6" O.C. AT INTERMEDIATE WALL FRAMING. INTERIOR SHALL BE SHEATHED WITH  $\frac{1}{2}$ " GYPSUM. EXTERIOR SHEATHING EDGES SHALL BE BLOCKED.

PLYWOOD ADJACENT TO PORCHES SHALL BE TREATED.

DO NOT SPICE MEBERS BETWEEN BEARINGS.

2-PLY MEMBER CONNECTION - NAIL 2x MEMBERS TOGETHER USING 3 ROWS OF 16d NAILS 9" O.C. (LVL NAILING TO BE 12" O.C.)

3-PLY MEMBER CONNECTION - NAIL 2x MEMBERS TOGETHER USING 3 ROWS OF 16d NAILS 9" O.C. (LVL NAILING TO BE 12" O.C.) CONNECTION(S) SHALL BE FROM BOTH SIDES.

4-PLY MEMBER CONNECTION - ATTACH PLIES TOGETHER USING 2 ROWS, STAGGERED OF  $\frac{1}{2}$ " THROUGH-BOLTS, WASHERS, AND NUTS 24" O.C. LOCATE ONE ROW 3" FROM TOP OF MEMBER, ONE ROW 3" FROM BOTTOM OF MEMBER.

CONCRETE NOTES:

CONCRETE SHALL HAVE MINIMUM 28 DAY COMPRESSIVE STRENGTH OF 3000psi.

REINFORCING STEEL SHALL BE ASTM GRADE 60.

CONCRETE FOOTING SHALL HAVE 3" CLEAR COVER AROUND REINFORCING BARS.

REINFORCING BARS SHALL HAV EMINIMUM LAP OF 25" OR 36 BAR DIAMETERS.

WELDED WIRE FABRIC SHALL CONFORM RO ASTM 185

PROVIDE CONTRACTION JOINTS AS REQUIRED (10'-12' O.C. +/-)

ALL CONCRETE WORK SHALL CONFORM TO NC BUILDING CODE.



1202-A Pollock Street
New Bern, NC 28560
2 5 2 - 6 3 3 - 0 3 2 2
www.goarchdesign.com

C O P Y R I G H T N O T E :

THESE PLANS ARE THE PROPERTY OF THE ARCHITECT.
THESE PLANS CONTAIN PROPRIETARY INFORMATION OF
GO ARCHITECTURAL DESIGN, PLLC. THEY ARE SUBJECT
TO FEDERAL COPYRIGHT AND OTHER APPLICABLE
FEDERAL AND STATE PROPERTY, TRADE AND RELATED
LAWS. THESE PLANS, INCLUDING THE INFORMATION
CONTAINED WITHIN, SHALL NOT BE SHARED,
REPRODUCED, DISTRIBUITED OR USED IN ANY WAY
WITHOUT WRITTEN CONSENT FROM THE ARCHITECT.
ANY FAILURE TO OBTAIN SUCH CONSENT IS A VIOLATION
OF LAW, AND MAY BE SUBJECT TO CIVIL AND CRIMINAL
PROSECUTION AND PENALTIES.

CUSTOM HOME

NEW BERN, NC 28560

**A-402** 

WALL SECTIONS

